This copied document is made available for the sole purpose of enabling its consideration and review as part of a planning process under the Planning and Environment Act 1987. The document must not be

NOTICE OF AN APPLICATION FOR PLANNING PERMIT 1987. The document must not be used for any purpose which may breach any copyright.

The land affected by the application is located at:	37 Bullock Island Road LAKES ENTRANCE VIC 3909 CA: 2009 CL: 09-346/11
The application is for a permit to:	Buildings and Works for a Multi-purpose Outbuilding (take away food premises)
A permit is required under the	ne following clauses of the planning scheme:
Planning Scheme Clause	Matter for which a permit is required
33.03-4 (IN3Z)	Construct a building or construct or carry out works.
44.04-2 (LSIO)	Construct a building or construct or carry out works.
The applicant for the permit is:	Lakes Entrance Fishermens Co-Op
The application reference number is:	5.2025.316.1

You may look at the application and any documents that support the application free of charge at: https://www.eastgippsland.vic.gov.au/building-and-development/advertised-planning-permit-applications

You may also call 5153 9500 to arrange a time to look at the application and any documents that support the application at the office of the responsible authority, East Gippsland Shire. This can be done during office hours and is free of charge.

Any person who may be affected by the granting of the permit may object or make other submissions to the responsible authority.

An objection must

- be made to the Responsible Authority in writing,
- include the reasons for the objection, and
- state how the objector would be affected.

The responsible authority must make a copy of every objection available at its office for any person to inspect during office hours free of charge until the end of the period during which an application may be made for review of a decision on the application.

The Responsible Authority will not decide on the application before:	Subject to the applicant giving notice
--	--

If you object, the Responsible Authority will tell you its decision.

This copied document is made available for the sole purpose of enabling its consideration and review as part of a planning process under the Planning and Environment Act 1987. The document must not be

April McDonald

used for any purpose which may breach any copyright.

From: Snapforms Notifications <no-reply@snapforms.com.au>

Sent: Wednesday, 17 September 2025 1:39 PM

To: Planning Unit Administration
Subject: Planning Permit application

Attachments: LEFL land title.pdf; LEFL Plan.pdf; Certificate Crown Folio Statement.pdf;

Planning_Permit_Application_2025-09-17T13-39-16_27820191_0.pdf; FW: Planning permit application for Off The Wharf cafe Lakes Entrance; JGA - LEFL Cafe, Viewing

Deck and Site Civil Worker.pdf

Planning Permit Application

A "Planning Permit Application" has been submitted via the East Gippsland Shire Council website, the details of this submission are shown below:

Applicant name: Lakes Entrance Fishermen's Limited

Business trading name: Off The Wharf Cafe

Email address: manager@lefcol.com.au

Postal address: Po Box 1125, Lakes Entrance

Preferred phone number:

Secondary phone number: 51551 688

Owner's name:

Owner's postal address: As above

Street number: 37

Street name: Bullock Island

Town: Lakes Entrance

Post code: 3909

Is there any encumbrance on the Title such as a restrictive covenant, section 173 agreement or other obligation such as an easement or building envelope?: No

Will the proposal result in a breach of a registered covenant restriction or agreement?: No

Existing conditions: We built a Cafe/Restaurant which has been for approximately 18 months ago.

Description of proposal: Off The Wharf Cafe & Restaurant, would like to build a small multi-purpose building, to accommodate a place where we can serve alcohol, coffee, takeaway meals, as well as a dry storage area.

This copied document is made available for the sole purpose of enabling its consideration and review as part of a planning process under the Planning and Environment Act 1987. The document must not be used for any purpose which may breach any copyright.

Estimated cost of development: \$6,000

Has there been a pre-application meeting: No

ExtraFile: 1

Invoice Payer: LEFL

Address for Invoice: Po box 1125 Lakes Entrance

Invoice Email: Manager@lefcol.com.au

Primary Phone Invoice:

Declaration: Yes

Authority Check: Yes

Notice Contact Check: Yes

Notice check 2: Yes

Privacy Statement Acknowledge: Yes

Full copy of Title: LEFL land title.pdf

Plans: LEFL Plan.pdf

Covenants agreements: Certificate Crown Folio Statement.pdf





This copied document is made available for the sole

Construction of this publication may be reproduced except as permitted by the Copyright Act 1988 (Cith), to complet with a statutory requiribinent or pure unit to a written altreament. The information is only valid at the time and in the form obtained from the LANDATA REGD TM System. None of the State of Victoria, its agents of defined to be a complet with a state of victoria and in the form obtained from the LANDATA REGD TM System. None of the State of Victoria, its agents of defined to be a complete with a state of victoria and years and the time and in the form obtained from the LANDATA REGD TM System. None of the State of Victoria, its agents of defined to be a complete with a state of victoria and years and the victoria and years and years

The Victorian Government acknowledges the Traditional Owners of Victoria and pays respects to their ongoing connectiop வெள்ற வாக்கு வெள்ற வாக்கள்கள் முற்ற வாக்கள் விள்ளது.

Environment Act 1987. The document must not be

REGISTER SEARCH STATEMENT (Title Seasch)for இவற்கு நிரும் இதியாக breach அள்கு opyright. Land Act 1958

VOLUME 12546 FOLIO 530

Security no : 124128162527J Produced 17/09/2025 11:45 AM

CROWN LEASE

LAND DESCRIPTION

Crown Allotment 2009, Crown Allotment 2017 and Crown Allotment 2055 Parish of Colquhoun.

Created by instrument AX989407D 13/05/2024

REGISTERED PROPRIETOR

Estate Leasehold EXPIRY DATE 21/02/2045 Sole Proprietor

ENCUMBRANCES, CAVEATS AND NOTICES

Any crown lease reservations exceptions conditions limitations and powers noted on the plan or imaged folio set out under DIAGRAM LOCATION below. For details of any other encumbrances see the plan or imaged folio set out under DIAGRAM LOCATION below.

DIAGRAM LOCATION

SEE TP972642V FOR FURTHER DETAILS AND BOUNDARIES

ACTIVITY IN THE LAST 125 DAYS

NIL

-----END OF REGISTER SEARCH STATEMENT------

Additional information: (not part of the Register Search Statement)

OTHER TITLES WITH INTERESTS AFFECTING THIS LAND 11726/946, 11726/959, 12515/836

ADMINISTRATIVE NOTICES

NIL

eCT Control 16667Y GADENS LAWYERS Effective from 12/07/2024

DOCUMENT END



This copied document is made available for the sole purpose of enabling its consideration and review as **Imaged Document Gover** in **Sheet** under the Planning and Environment Act 1987. The document must not be used for any purpose which may breach any copyright.

The document following this cover sheet is an imaged document supplied by LANDATA®, Secure Electronic Registries Victoria.

Document Type	Plan
Document Identification	TP972642V
Number of Pages	64
(excluding this cover sheet)	
Document Assembled	17/09/2025 11:45

Copyright and disclaimer notice:

© State of Victoria. This publication is copyright. No part may be reproduced by any process except in accordance with the provisions of the Copyright Act 1968 (Cth) and for the purposes of Section 32 of the Sale of Land Act 1962 or pursuant to a written agreement. The information is only valid at the time and in the form obtained from the LANDATA® System. None of the State of Victoria, LANDATA®, Secure Electronic Registries Victoria Pty Ltd (ABN 86 627 986 396) as trustee for the Secure Electronic Registries Victoria Trust (ABN 83 206 746 897) accept responsibility for any subsequent release, publication or reproduction of the information.

The document is invalid if this cover sheet is removed or altered.

This copied document is made available for the sole purpose of enabling its consideration and review as

					purpose of enabling	g its consideration and re	eview as
EDI	TION	1		TITLE	PLANart of a planning	proces s mgg26429 nn 987. The document mus	ing and t not be
Location of Parish: Section Crown		-	.QUHOU), 2017 8			ti wh ich may breach any	
E -	Encumbering	Easemei		ement Information Encumbering Easement Easement	t (ROAD) A - Appurtenant	THIS PLAN HAS BEEN PREPARED BY LAND REGISTRY, LAND VICTORIA FOR TITLE DIAGRAM PURPOSES AS PART OF THE LAND TITLES AUTOMATION PROJECT.	
Easement Reference	Purpose / Ai	uthority	Width (Metres)	Origin	Land benefitted / In favour of		
						COMPILED: 13/05/2024	
						VERIFIED: NT	
						Assistant Registrar of Titles	
	1				1	1	

SEE PLAN ATTACHED TO CROWN LEASE PAGES

LENGTHS ARE IN MOT SHEET SIZE SCALE A3 DEALING NO.: AX989407D


Sheet par 64 Sheets 0/2025

This copied document is made available for the sole purpose of enabling its consideration and review as part of a planning process under in a planning and Environment Act 1987. The document must not be used for any purpose which may breach any copyright.

Attachment 1 Premises Plan

PLAN OF CRO	WN ALLO	IMENT	EDITION 1	OP126528P
LOCATION OF LAND			NOTATIONS	<u> </u>
COUNTY: PARISH: CROWN ALLOTMENT:	TAMBO COLSUMBUN 2055			
SPI: TILE REFERENCE:	2055\PP2412 C/F VOL 1860 FOL	498		
M5AZ020 Z0NE 575	22.00 St. 22.00	21-98 80-15: 2055 612m ² 21-98 259-21: UNNINGHAME	2009 21009 ARH	2017
ORIGINAL SHEET SIZE SCALE 9 9 9 8 1:500 INSERT SEE 9 1:500 INSERT SEE	85 20 S	Poul Androny Doyer of 15 ado under my direction as an is socurate and correct	nd experimination in proceedances with By regressions the exhapters bounds ying (Codestral Surveys) Regulate https://buyer/2006/2003	. 387's cently that that plac has been prepared from a survey the Surveying Act 2004 and completed on 09005(2025, that if the and that the survey accuracy oppored with that required
SURVEYOR-GENERAL V	ECTORIA S		Viceny Dayer, Licensed Storoyer	Cardified by Ching Soundy Surveyor-Cemental Dis 39 AM 2011/2003

This copied document is made available for the sole purpose of enabling its consideration and review as part of a planning process under in Planning and Environment Act 1987. The document must not be used for any purpose which may breach any copyright.

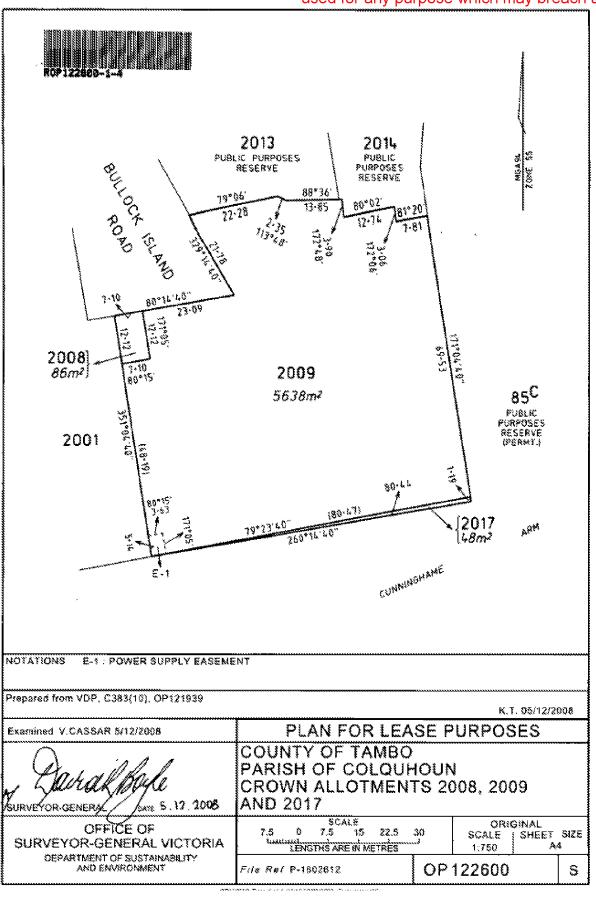


Landlord reference: 1602612

13294446v5

This copied document is made available for the sole purpose of enabling its consideration and review as part of a planning process under the Pantany and Environment Act 1987. The document must not be used for any purpose which may breach any copyright.

Attachment 2 Access Plan

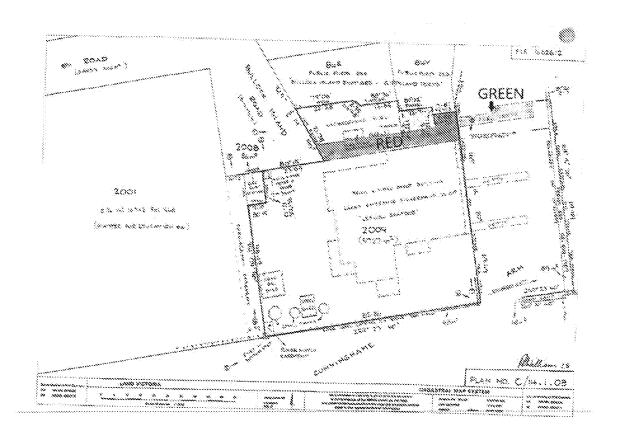

Landlord reference: 1602612

13294446v5



This copied document is made available for the sole yright State of Victoria. This publication is copyright and includes confidential information. No part may be reproduced by any process except in appendix equivible to the Scinglish Act increased to a written eview as enement. The State of Victoria does not warrant the accuracy or completeness of the information in this publication are advisory of victoria does not warrant the accuracy or completeness of the information in this publication are advisory of victoria does not warrant the accuracy or completeness of the information in the information.

The State of Victoria Charles are not warrant the accuracy or completeness of the information in the information of the state of victoria does not warrant the accuracy or completeness of the information in the information of victoria does not warrant the accuracy or completeness of the information in the information of victoria does not warrant the accuracy or completeness of the information in the information in the information of victoria does not warrant the accuracy or completeness of the information in the information of victoria does not warrant the accuracy or completeness of the information in the information of victoria does not warrant the accuracy or completeness of the information in the information of victoria does not warrant the accuracy or completeness of the information in the information of victoria does not warrant the accuracy or completeness of the information in the information of victoria does not warrant the accuracy or completeness of the information in the information of victoria does not warrant the accuracy or completeness of the information in the information of victoria does not warrant the information of victoria does not warra part of a planning process under the Planning and Environment Act 1987. The document must not be used for any purpose which may breach any copyright.

CROWN FOLIO STATEMENT

VOLUME 11726 FOLIO 940 No CofT exists

Security no : 124128148519K Produced 17/09/2025 07:23 AM

CROWN FOLIO

LAND DESCRIPTION

Crown Allotment 2014 Parish of Colquhoun. PARENT TITLE Volume 11698 Folio 008 Created by instrument MI073541U 06/08/2016

CROWN LAND ADMINISTRATOR

SECRETARY TO THE DEPARTMENT OF ENVIRONMENT, LAND, WATER AND PLANNING of 8 NICHOLSON STREET EAST MELBOURNE VIC 3002 MI073541U 06/08/2016

STATUS, ENCUMBRANCES AND NOTICES

RESERVATION MI073543Q 06/08/2016 TEMPORARY PUBLIC PURPOSES GP2703

INDIGENOUS LAND USE AGREEMENT as to part MI073544N 06/08/2016 NATIVE TITLE DETERMINATION VID6007/1998

DIAGRAM LOCATION

DOCUMENT END

SEE CD031066C FOR FURTHER DETAILS AND BOUNDARIES

ACTIVITY IN THE LAST 125 DAYS

NIL -----END OF CROWN FOLIO STATEMENT------Additional information: (not part of the Crown Folio Statement) Street Address: "LEFCOL" 37 BULLOCK ISLAND ROAD LAKES ENTRANCE VIC 3909

John Gardner & Associates

Consulting Engineers | Structural & Civil

27 The Terrace Metung VIC 3904 Telephone (03) 5156 2726 Mobile 0429 646 022 email john@johngardner.com.au



LEFL CAFE, VIEWING DECK & SITE CIVIL WORKS

37 BULLOCK ISLAND ROAD - LAKES ENTRANCE.

CONTENTS:

S0: GENERAL NOTES AND DRAWING SCHEDULE

S1: CAFE SUPPORT PLATFORM PLANS

S2: CAFE SUPPORT PLATFORM DETAILS

S3: CAFE STEEL PLAN AT DECK LEVEL

S4: CAFE ROOF & PLANT PLATFORM PLAN

S5: VIEWING DECK & RAMP - FOOTINGS PLAN

S6: VIEWING DECK & RAMP - FRAMING PLAN

S7: SITE CIVIL DEMOLITION PLAN

S8: SITE CIVIL PLAN - SOUTHERN SECTION

S9: SITE CIVIL PLAN - NORTHERN SECTION

S10: PILED DECK & ENTRY RAMP DETAIL

S11: CIVIL DETAILS

S12: VIEWING DECK & RAMP DETAILS

S13: CAFE ROOF DETAILS

S14: FREE FRAMED ROOF ABOVE PLANT PLATFORM

ADVERTISED

This copied document is made available for the sole purpose of enabling its consideration and review as part of a planning process under the Planning and Environment Act 1987. The document must not be used for any purpose which may breach any copyright.

GENERAL NOTES

ELEWENT AND LOCATION	WIN GRADE (UNLESS NOTED)	SLUVP (m
BLINDING & MASS	N15	100
FOOTINGS & PIERS	N25	80
SLABS ON GROUND	N25	60
SUSPENDED SLABS & BEAMS	N32	80
STAIRS	N32	80
SWMMING POOL	N32	80
COLUMNS (UNLESS NOTED)	N40	80
CORE WALLS	N4D	80
PRECAST PANELS	N32	60

ELEMENT	SHELTERED FORMWORK	GROUNDWATER & WEATHER	DTHEA
PADS & PILE CA	es -	65mm	75mm
TRIP FOOTINGS	2	50mm	50mm
COLUMNS	40mm	45mm	75mm
BEAMS	25mm	40mm	-
SHATE & STAIRS	25mm	35mm	-
CORE WALLS	35mm	35mm	35mm
RECAST WALLS	35mm	35mm	35mm
POOL WALLS	35mm	-	-
POOL SLABS	30mm	-1	100

MAS	ONRY
M1.	THE SOFTITS OF CONCRETE BEAMS AND SLABS SHALL BE SEPARATED FROM SUPPORTING MASONRY BY TWO LAYERS OF A SUITABLE BOND BREAKER (eg. MALTHOD OR SMILAR).
	PLACED OVER A SMOOTH AND REGULAR SURFACE. FILL ANY DEPRESSIONS OR PREGULARITES WITH WORTAR
M2.	THE TYPE AND THICKNESS OF BRICKWORK AND BLOCKWORK SHALL BE AS SHOWN

TENDER REVISION ISSUE 13 JULY 2021

Date Commenced 19024

 Rev
 Date
 Summary

 A
 28.6.21
 Drawings \$14 & \$15 added

Lakes Entrance Fisherman Ltd. 37 Bullock Island Lakes Entrance VIC 3909 Email manager@lefcol.com.au

JP Design Australia Pty.Ltd. Mbl. 0417 102 153 Email james@jrdal.com.au



John Gardner & Associates Consulting Engineers | Structural & Civil


27 The Terrace, Metung Vic 3904 Telephone 0429 646 022 email john@johngardner.com.au



LEFL SITE 37 BULLOCK ISLAND LAKES ENTRANCE

GENERAL NOTES AND PILED DECK DETAILS

This copied document is made available for the sole purpose of enabling its consideration and review as part of a planning process under the Planning and Environment Act 1987. The document must not be used for any purpose which may breach any copyright.

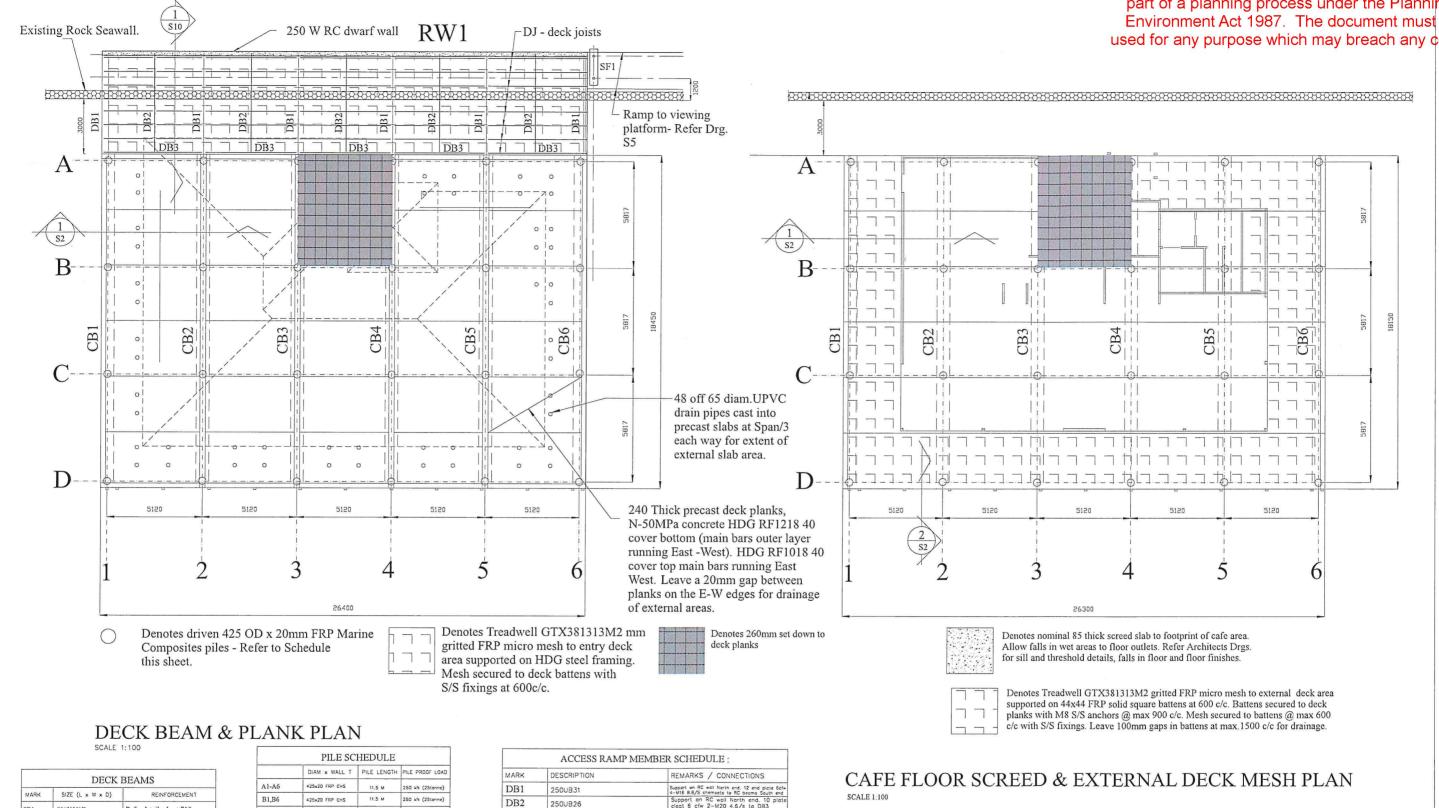

	DECK	BEAMS
MARK	SIZE (L × W × D)	REINFORCEMENT
CB1	800X550D.	Refer details sheet S10
CB2,5	800X550D.	Refer details sheet S10
CB6	800X550D.	Refer details sheet S10
CB3,4	800X550D (810D North end).	Refer details sheet S14

	PILE SC	HEDULE	
	DIAM x WALL T	PILE LENGTH	PILE PROOF LOAD
A1-A6	425x20 FRP CHS	11.5 M	250 kN (25tonne)
B1,B6	425x20 FRP CHS	11.5 M	250 kN (25tonne)
B2-B5	425x20 FRP CHS	14.6 M •	500 kN (50tonne)
C1,C6	425x20 FRP CHS	11.5 W	250 kN (25tonne)
C2-C5	425x20 FRP CHS	14.8 M •	500 kN (50tonne)
D1-D6	425x20 FRP CHS	11,5 M	250 kN (25tonne)
TEST PILES			
A1,D6	425x20 FRP CHS		250 kN (50tonne)
B3,C4	425x20 FRP CHS		500 kN (50tonne)

A1,D6	425x20 FRP CHS	250 kN (50tonne)
B3,C4	425x20 FRP CHS	500 kN (50tonne)
	m length achieved with ed. Splice at embedded	submitted 900 spigot splice detail lend of pile.
0	destation.	10000

MARK	DESCRIPTION	REMARKS / CONNECTIONS
DB1	250UB31	Support on RC well North end, 12 end plote 6cfw 4-M16 8.8/S chemsets to RC becms South end
DB2	250UB26	Support on RC wall North end, 10 plate cleat 6 cfw 2-M20 4.6/s to DB3
DB3	250UB31	10 plate cleat 6cfw 2-M20 4.6/S each end.
DJ1	100 PFC @ 600 c/c	8 plate cleat 5 cfw 2- M12 4.6/S each end

NOTES TO PRECAST DECK PLANKS

PRECAST DECK PLANKS TO BE CAST ON STEEL TROWEL FINISHED CASTING BED OR STEEL PLATE CASTING BED CONCRETE TO BE 50MPa MAXIMUM 65mm SLUMP. CONCRETE TO BE THOROUGHLY VIBRATED AND STEEL TROWEL FINISHED TOP FACE TO BE CURED WITH AN APPLIED CURING COMPOUND. LIFTING ANCHORS TO BE \$/S\$ AND TO BE EITHER TOP FACE LIFTERS OR FULLY RECESSED EDGE LIFTERS - FINAL DESIGN BY PRECASTER

TENDER REVISION ISSUE 13 JULY 2021

Revis	sion		
Rev	Date	Summary	B
Α	15.6.21	Piles changed to FRP and driven depth increased, Concrete Beams depth increased to 550	JA
		Cafe screed reduced to 85mm, spec on precast planks and FRP mesh altered	JA
		Drain holes added to floor planks, FRP extende into chair store	JA
В	30.6.2021	Pile schedule altered, splice note added for piles B2-B5 and C2-C5	JA
С	5.7.2021	Pile schedule corrected	JA
D	13.7.21	Deck Plank set down 260 mm Grids 1/B & 3/4, CB3&4 altered in schedule	JA
21			



Lakes Entrance Fisherman Ltd. 37 Bullock Island Lakes Entrance VIC 3909 Email manager@lefcol.com.au

JP Design Australia Pty.Ltd. Ph. 5977 7411 Mbl. 0417 102 153

Email james@jrdal.com.au



John Gardner & Associates Consulting Engineers | Structural & Civil

27 The Terrace, Metung Vic 3904 Telephone 0429 646 022 email john@johngardner.com.au


L	

ob title	
	LEFL SITE
	37 BULLOCK ISLAN
	LAKES ENTRANCE

ND Drawing title CAFE SUPPORT PLATFORM PLA

	COPYRIGHT	JOHN A. GARD	NER & ASSOC	IATES 20
	Date Comm	enced .	Job No.	
Date	Date Release	ed .	190	24
	Scale	1:100 @: A1.	170	4 -T
	Design	JAG	Drawing No.	Rev.
ANS	Drawn	JAG	Q1	\Box
	C1 -1 1		$\mathcal{O}_{\mathbf{I}}$	

This copied document is made available for the sole purpose of enabling its consideration and review as part of a planning process under the Planning and Environment Act 1987. The document must not be used for ally purpose which may breach any copyright.

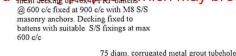

for N32 shear pin 900 long cast 500 into pile plug on centre line of pile (typical all beam to pile locations). -500Deck planks to North & South sides to have a 250W x 320D

upstand kerb. 2-N16 top & botton & R10 ligs @ 400 C/C. Note kerb depth increases to 580 for plank edge A3 to A4.

6 - N20 rebar R6 ligs min 50 cover at 300 c/c N50 MPa concrete plug continu pour into pile and precast beam (typical all

piles and beams)

De-water pile and fill to 900 below beam soffit with

dry sand (typical all piles)

TYPICAL PILE TO BEAM CONNECTION

240 deep precast deck planks

on 40mm levelling grout. 20mm gap between planks to

planks to ensure drainage gap is beyond extent of floor screed

allow draianage of external deck area. Adjust width of

Poured in-situ kerbing on East and West sides of deck to tie planks and precast beams together. Kerb upstand 250W x 360D . 2-N16 top Precast plank stop end forms to allow top & bottom fabric to & bottom with R10 ligs @ 400 C/C. run through (typical) Outer ligs to CB1 & CB6 extended to tie into poured in-situ kerbing. 40mm levelling grout between precast beams and precast planks 75 diam, corrugated metal grout tubehole for N32 shear pin 900 long cast 500 into pile plug on centre line of pile (typical all beam to pile locations). Structural non shrink CB2 similar

> DETAIL A - EAST & WEST EDGE DETAIL & TYPICAL PILE CONNECTION TO PRECAST BEAMS

SCALE 1:20

85 mm screed slab (25 MPa SL72

CB₂

40mm N40MPa levelling grout between precast beams and precast planks (typical)

30 cover top) for footprint of

building over. Refer architects drawings for exact setout, floor

finishes, falls and sill details.

N20 dowels x 600 long Poured in-situ connection strip @ 500 c/c cast 300 into 350 wide to tie planks to precast beams, N50 MPa concrete CB₂ N12 ligs @ 400 C/C cast into top of precast beams. Ligs project Into in-situ pour strip (CB 2,3,4,&5.) 800 2-N16 long'tdl lap 600 as necessary (typical)

> **DETAIL B - INTERNAL** DECK PLANK DETAIL

SCALE 1:20

TENDER REVISION *ISSUE* 13 JULY 2021

COPYRIGHT JOHN A. GARDNER & ASSOCIATES 202 Date Commenced Job No Date Released

Lakes Entrance Fisherman Ltd. JP Design Australia Pty.Ltd. 37 Bullock Island Ph. 5977 7411 Lakes Entrance VIC 3909 Mbl. 0417 102 153 Email manager@lefcol.com.au Email james@jrdal.com.au


John Gardner & Associates Consulting Engineers | Structural & Civil 27 The Terrace, Metung Vic 3904 Telephone 0429 646 022 email john@johngardner.com.au




Job title
Drawing title

LEFL SITE 37 BULLOCK ISLAND LAKES ENTRANCE

Scale JAG Drawing No.
JAG 2 Design CAFE SUPPORT PLATFORM DETAILS Checked

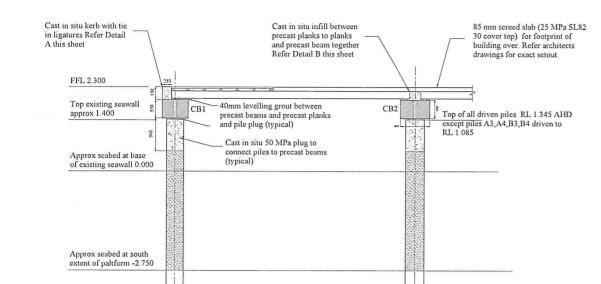

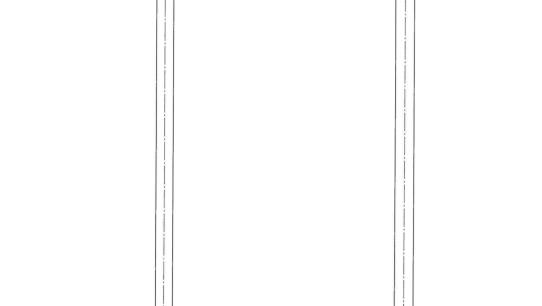

SECTION

GENERAL ARRANGEMENT

This copied document is made available for the sole purpose of enabling its consideration and review as part of a planning process under the Planning and Environment Act 1987. The document must not be used for any purpose which may breach any copyright.





P1 baseplate detail

300x250x16 plate FSBW to P1 post. 4 - M20 8.8 chemset bolts on 230x180 pitch grid. Chemsets min. 200 into precast deck planks, min. 100 bolt projection. 30mm non shrink levelling grout. Trim excess bolt projection above nut.

P2 baseplate detail

275x275x16 plate FSBW to P2 post. 4 - M20 8.8 chemset bolts on 205x205 pitch grid. Chemsets min. 200 into precast deck planks, min. 100 bolt projection. 30mm non shrink levelling grout. Trim excess bolt projection above nut.



P3 baseplate detail

250x250x12 plate 8 cfw to P3 post. 4 - M16 8.8 chemset bolts on 180x180 pitch grid. Chemsets min. 200 into precast deck planks, min. 100 bolt projection. 30mm non shrink levelling grout. Trim excess bolt projection above nut.



1 88

1.89

Not: Perimeter post base plates offest to ensure full cover by

1.87

AA

A

TENDER REVISION ISSUE 13 JULY 2021

COPYRIGHT JOHN A. GARDNER & ASSOCIATES 2020
 on
 Date
 Summary

 28.6.21
 P3 POSTS ADDED

 13.7.21
 2 off P3 posts added. Note re. post base offsets added
 Date Commenced John Gardner & Associates 19024 LEFL SITE Date Released JP Design Australia Pty.Ltd. Ph. 5977 7411 Mbl. 0417 102 153 Lakes Entrance Fisherman Ltd. 37 BULLOCK ISLAND LAKES ENTRANCE 37 Bullock Island B Rev. 27 The Terrace, Metung Vic 3904 Telephone 0429 646 022 S3 Lakes Entrance VIC 3909 Design Email manager@lefcol.com.au Email james@jrdal.com.au oving title
STEEL POST BASE PLATE PLAN & DETAILS email john@johngardner.com.au

6

5

AAFor Entry Ramp Refer to \$1 and \$10. A B Void for Exhaust hood. Hood suppor on stud wall South side & RB13 plus fitments on Noth side. D **ROOF PLAN** SCALE 1:100 Notes: Steel wokshop drawings to be subnitted to Engineer for approval a minimu seven days before fabrication. Refer Drawing S15 for free framed roof over plant platform

ADVERTISED

This copied document is made available for the sole purpose of enabling its consideration and review as part of a planning process under the Planning and Environment Act 1987. The document must not be used for any purpose which may breach any copyright.

uset	a for ally purpose	5 WHICH Hay DIEA
MARK	DESCRIPTION	REMARKS / CONNECTIONS
RB1	250 PFC	Refer typical details on S13
RB2	230 PFC	Refer typical details on S13
RB3	230 PFC	Refer typical details on S13
RB4	230 PFC	Refer typical details on S13
RB5	230 PFC	Refer typical details on S13
RB6	230 PFC	Refer typical details on S13
RB7	230 PFC	Refer typical details on S13
RB8	230 PFC	Refer typical details on S13
RB9	310UB46	FSBW @ crank, 10 plate cleat 6efw 2-M20 8 8/s each end. Refer detail on Drg. S13
RB10	310UB32	10 Pl. cleat 6cfw 2-M20 8.8/s each end to Pl & RB
RB11	230 PFC	10 P1 cleat 6 cfw 2-M20 8.8 to P1 post & HB1
RB12	230 PFC - 2 spans	10 P1 cleat 6 cfw 2-M20 6 8 to P3 post full reating to west P4 post 10 end plate 2-M20 8 8 /S splice to RB13
RB13	230 PFC - 2 spans	Full seating on east P4 post 10 end plate splice to RB12 full seating on P3 posts.
RB14	230 PFC - 2 spans	10 plate cleat 6 cfw 2-M20 8 8/S to west P3 post and TB1. Full seating on P3 post.
RB15	200 PFC	10 Pl. cleat 6 cfw 2-M20 8 8/S to RB15
RB16	200 PFC	10 PL cleat 6 cfw 2-M20 8.8/s to RB14 & RB12
нв1	250 PFC	Hip Beam - 6 plate cleat 6 cfw 2 - M12 bolts each RF1 rafter, 10 plate cleat 6 cfw 2-M20 8.8/S each en-
нв2	250 PFC	Hip Beam - 6 plate cleat 6 cfw 2 - M12 bolts each RF1 rafter, 10 plate cleat 6 cfw 2-M20 8.8/S each end
нв3	100x50x4.0 RHS	4 off to form cap to tower- cfw to each other and to P2 and TB2 tower members
P1	150x100x6 RHS	External facade posts. Refer details on S13.
P2	125x125x8 SHS	Posts to tower frame. *cfw to laterals to create a fully welded tower frame.
Р3	100x100x4 SHS	Refer details on S13
ST	Station Trusses at 900 c/c	Trusses to manufacturers Design
HT	Hip Truss	Trusses to manufacturers Design
GT2700	Girder Truss at 2700	Trusses to manufacturers Design Triple studs in walls at support points
GT	Girder Truss	Trusses to manufacturers Design Double studs in walls at support points
RF1	290x35 LVL15 @ 600 c/c	Refer details on S13. Rafters south side of RB1 nogged at Span/3
TR1	190x45 LVL15	Trimmer to terminate plant platform
PJ1	240x42 LVL15 @ 450 c/c	Plant room joists. Fully nailed joist
11	200x42 LVL15	hangers each end.
L2	90x45 MGP10 KDPine	Double studs each end
TB1	125x125x8 SHS	Laterals 8 cfw to P2 posts to create
TB2	125x125x8 SHS	a fully welded tower frame. Laterals 8 cfw to P2 posts to create
		a fully welded tower frame.
XXX TS	Girder Truss	JAMB STUD
M DS	Girder Truss	
173 D2		-
WB	PRYDA MINI BRACE	TO MANUFACTUREDE DETAIL C
	THE WHITE BUNKE	TO MANUFACTURERS DETAILS
SWB	HARDIES SHEET WALL BRACE	TYPE 'B' NAILING PATTERN REFER TO DRAWING 11052 - S7 FOR DETAILS

75x75x6 angle legs 60x60x5 laterals all 6cfw. 8 plate base 6 cfw to each leg. 2-M20 8.8/S to matching cheek plate

6cfw to top flange of HB3 hip beams. Refe architects drawings for feature

details

TB2

TB1

FOYER TOWER

TB1

TB1

SECTION

TB1

Tower fully welded structures. Some site welding at splices necessary.

P2

- NOTES

 1. ALL EXTERNAL STEELWORK & WALL STEEL LINTELS TO BE HOT DIPPED GALVANISED.

 2. ALL BEAMS AND LINTELS TO BEAR MINIMUM 110 ON MASONRY
 (OR ON DOUBLE STUD) EACH END, UNLESS NOTED OTHERWISE.

 3. ALL KDITP TO BE TREATED AS FOLLOWS

 EXTERIOR ABOVE GROUND USE HAZARD 3 RATING TO AS1604.

 EXTERIOR BELOW GROUND USE HAZARD 3 RATING TO AS1604.

WALL FRAMING SPECIFICATION

EXTERNAL WALLS - 140X35 MGP10 T2 studs at 450 c/c nogged at third height points.

INTERNAL WALLS - 90X45 MGP10 T2 studs at 450 c/c nogged at mid height.

TENDER REVISION ISSUE 13 JULY 2021

	COPYRIGHT JOHN A	. GARDI	NER & ASSOC	IATES 202
	Date Commenced		Job No.	
	Date Released		190	24
	Scale	1:100	170	4 7
	Design	JAG	Drawing No.	Rev.
RM	Drawn	JAG	S4	\perp D
	Charled			

Architects Lakes Entrance Fisherman Ltd. 37 Bullock Island JR Design Australia Pty.Ltd. Ph. 5977 7411 Mbl. 0417 102 153 Lakes Entrance VIC 3909 Email manager@lefcol.com.au Email james@jrdal.com.au


John Gardner & Associates Consulting Engineers | Structural & Civil

TB1


27 The Terrace, Metung Vic 3904 Telephone 0429 646 022 email john@johngardner.com.au

Job title LEFL SITE 37 BULLOCK ISLAND LAKES ENTRANCE
Drawing title CAFE ROOF PLAN & PLANT PLANT

	COPYRIGHT JOHN	A. GARDI	NER & ASSOC	ATES :
The owner	Date Commenced		Job No.	
LEFL SITE	Date Released .		190	24
37 BULLOCK ISLAND LAKES ENTRANCE	Scale	1:100	170	47
EARLS LIVINAINCE	Design	JAG	Drawing No.	Rev.
g title CAFE ROOF PLAN & PLANT PLATFORM	Drawn	JAG	S4	
CAFE ROOF PLAN & PLANT PLATFORM	Checked		5.	-

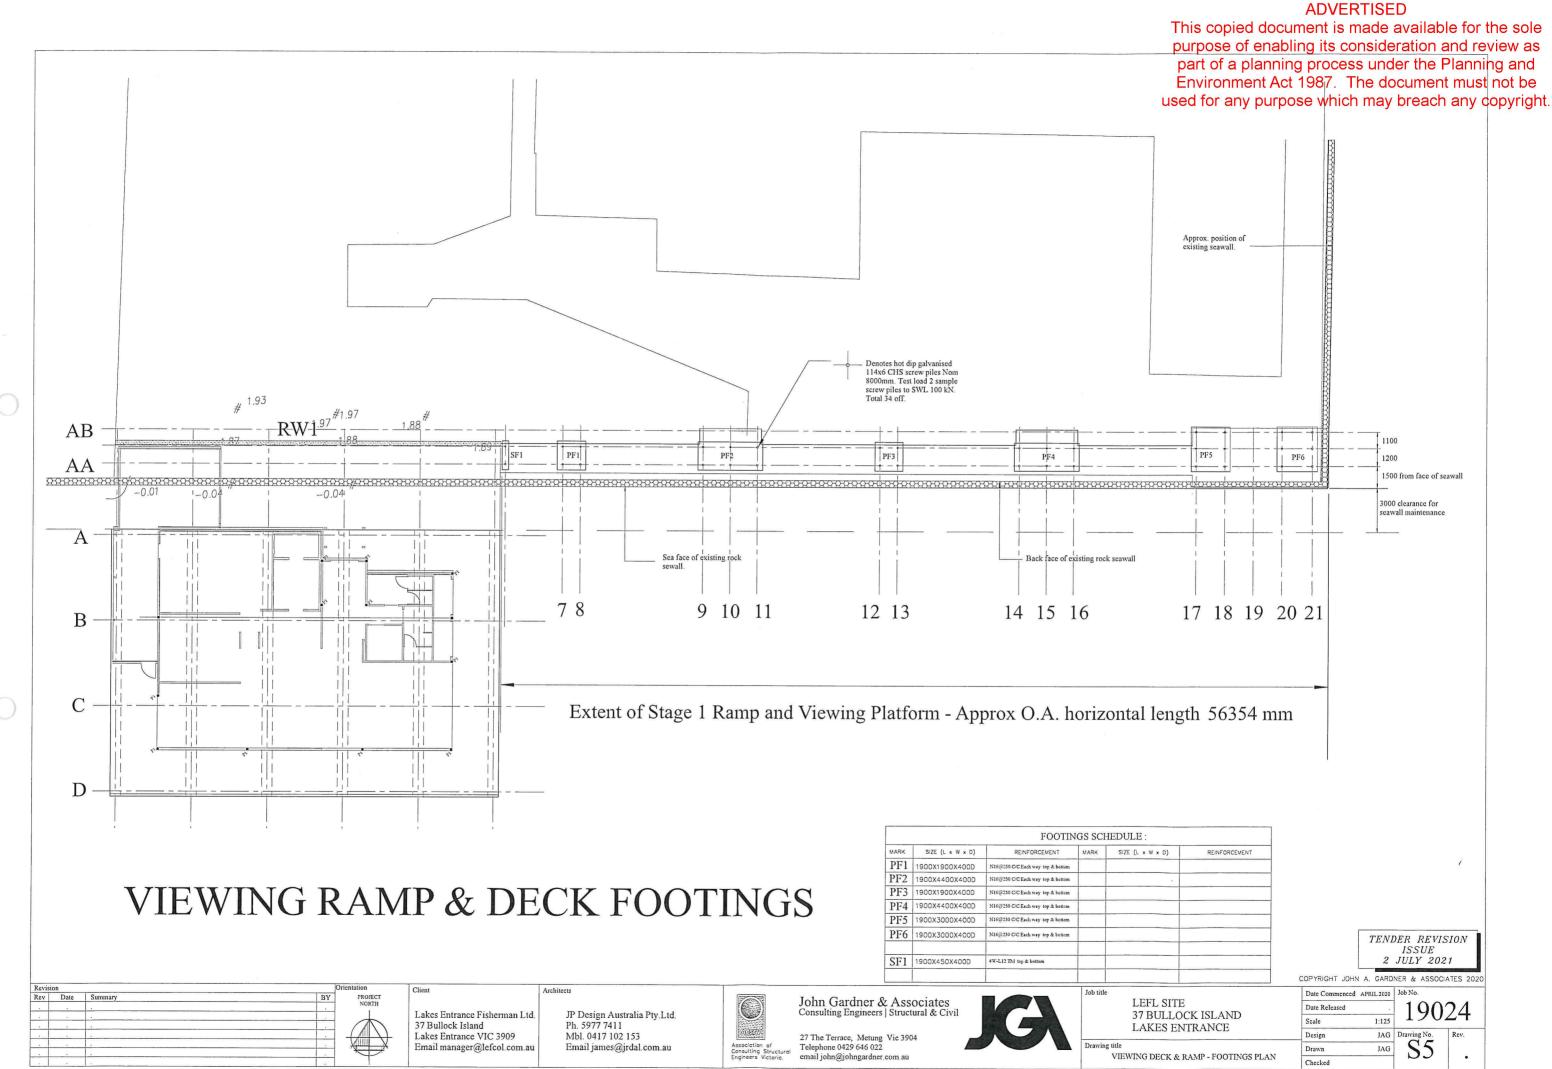

This copied document is made available for the sole purpose of enabling its consideration and review as part of a planning process under the Planning and Environment Act 1987. The document must not be used for any purpose which may breach any copyright.

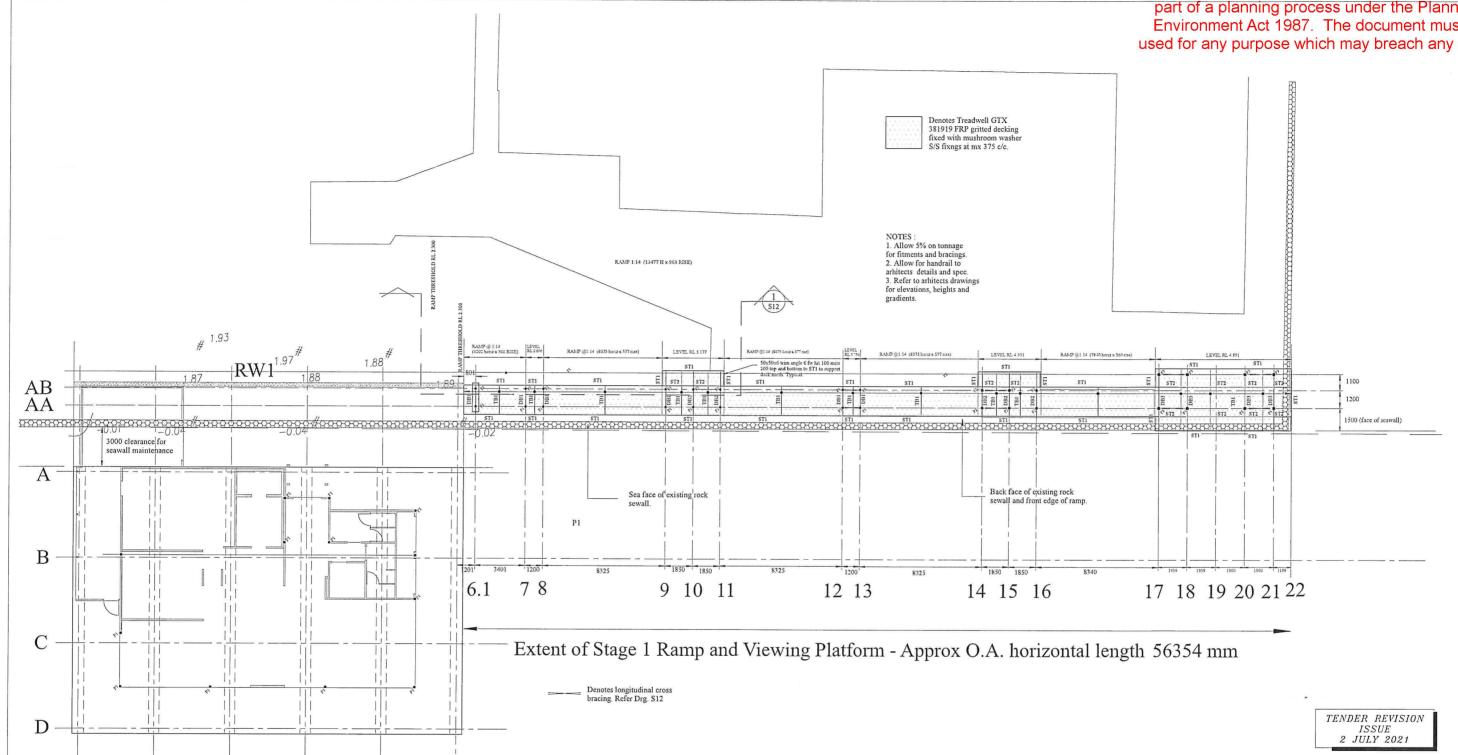

VIEWING RAMP & DECK FRAMING

Notes:

Refer Drg Sheets S10, S11 & S12 for ramp and deck details
All Transverse frames Grids 6.1 to 16 to be fully welded prior to HDG

Transverse frames Grids 17,18, 20 & 21 to have bolted post to headstock connection, refer detail Drg.S12

MEMBER SCHEDULE:			MEMBER SCHEDULE:		
MARK	DESCRIPTION	REMARKS / CONNECTIONS	MARK	DESCRIPTION	REMARKS / CONNECTIONS
ST1	250PFC stringers	Min. 10 plate cleat 2-MB.B/S bolts each end.	Р3	150x150x6 SHS	Calumns, grids 17,18.20 & 21
DB1	100x100x6.0 SHS Headstock	Head stock 6 cfw to posts	ST2	180 PFC beneath FRP decking	Bolted connection to headstocks.
DB2	125Dx75Wx6.0 RHS Headstock	Slot into posts and 6cfw both sides			
DB3	150Dx100x9.0 RHS Headstock	Slot into posts and 6cfw both sides			
TB1	75x75x6 angle @600 c/c	6cfw to ST1 Stringers - Refer Details			
P1	100x100x6.0 SHS	Columns grids 6.1 to 13			
P2	125x125x6 SHS	Columns, grids 14 to 16		1.	

VIEWING DECK & RAMP - FRAMING PLAN

Kern	SIGH		
Rev	Date	Summary	BY
Α	18.3.2021	Reference to Stage 2 viewing platform removed	JAG
			i i
200			
(9)			
2		<u>.</u>	
8			


Lakes Entrance Fisherman Ltd.
37 Bullock Island
Lakes Entrance VIC 3909
Email manager@lefcol.com.au

JP Design Australia Pty.Ltd. Ph. 5977 7411 Mbl. 0417 102 153 Email james@jrdal.com.au




John Gardner & Associates Consulting Engineers | Structural & Civ


27 The Terrace, Metung Vic 3904 Telephone 0429 646 022 email john@johngardner.com.au

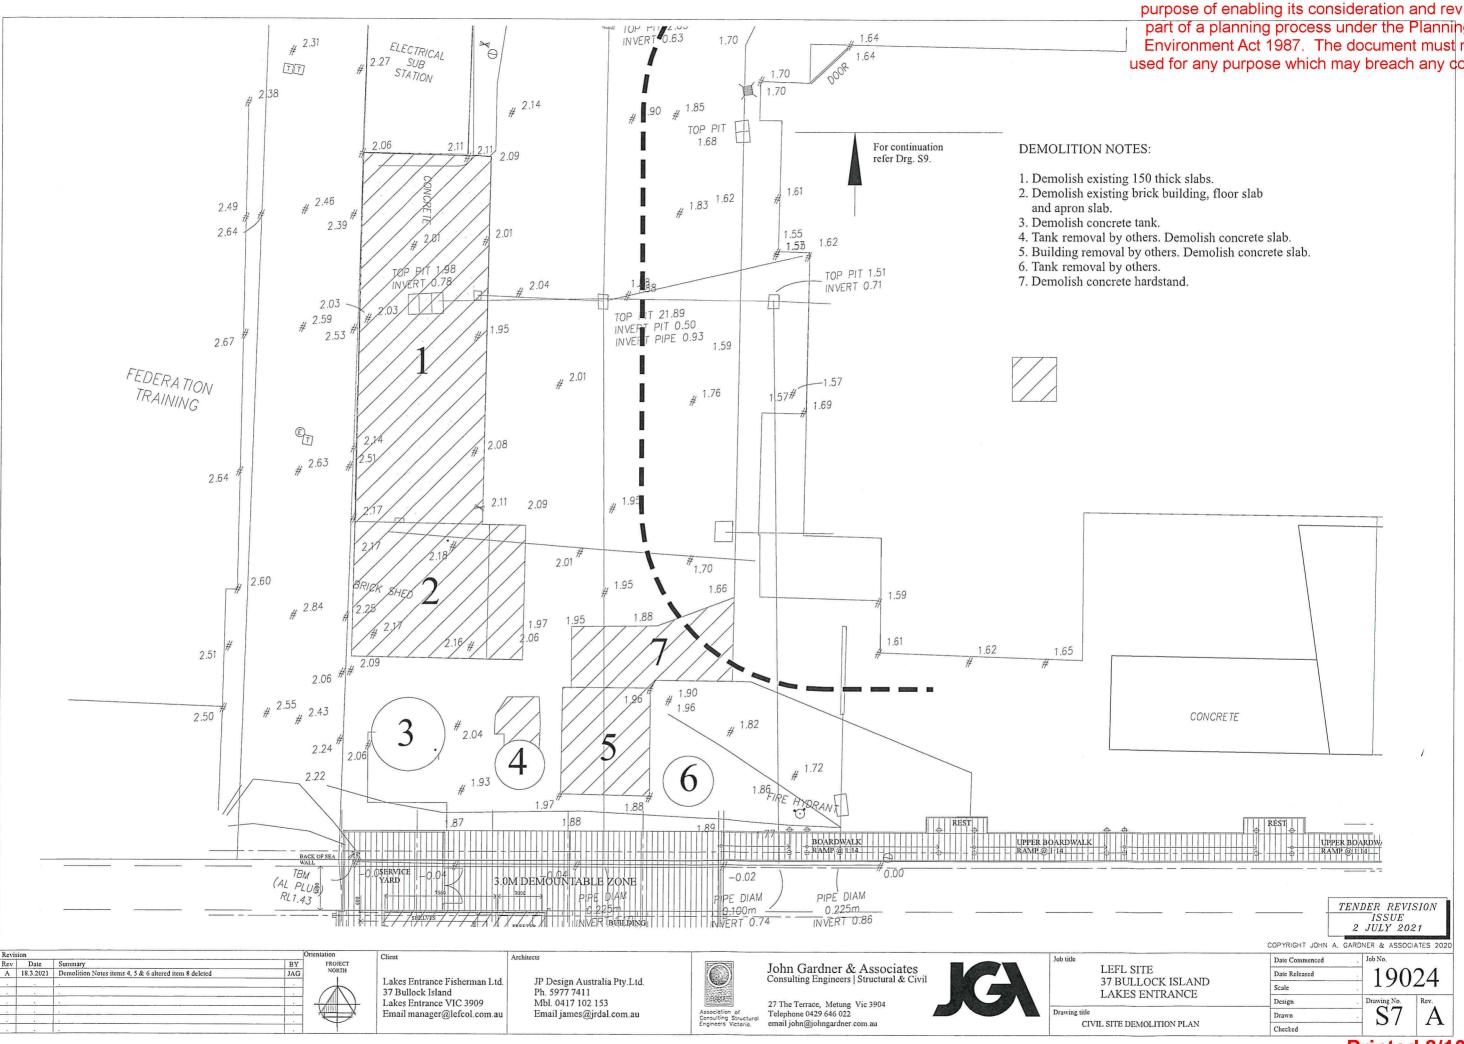LEFL SITE 37 BULLOCK ISLAND LAKES ENTRANCE 

ADVERTISED This copied document is made available for the sole purpose of enabling its consideration and review as part of a planning process under the Planning and NEW GRATED PIT CONCRETE HD HDG V GRATE PF5 PF4 seawall maintenance Back face of existing rock seawall TENDER REVISION ISSUE 2 JULY 2021 14 15 16 17 18 19 20 21

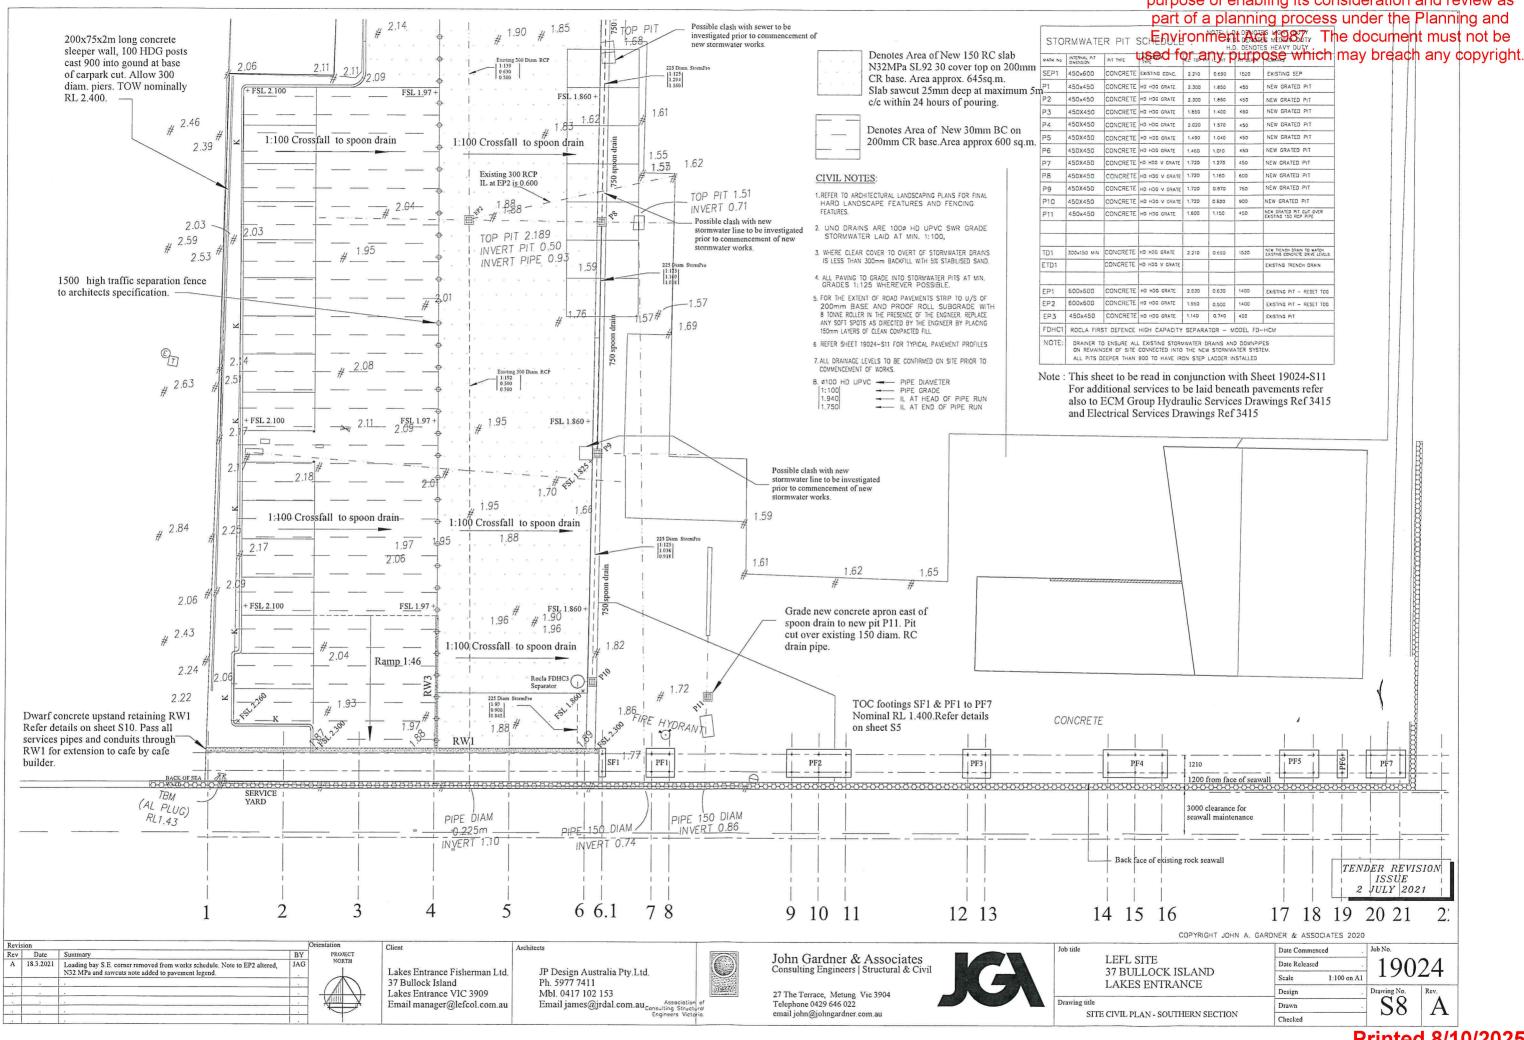


This copied document is made available for the sole purpose of enabling its consideration and review as part of a planning process under the Planning and Environment Act 1987. The document must not be used for any purpose which may breach any copyright.

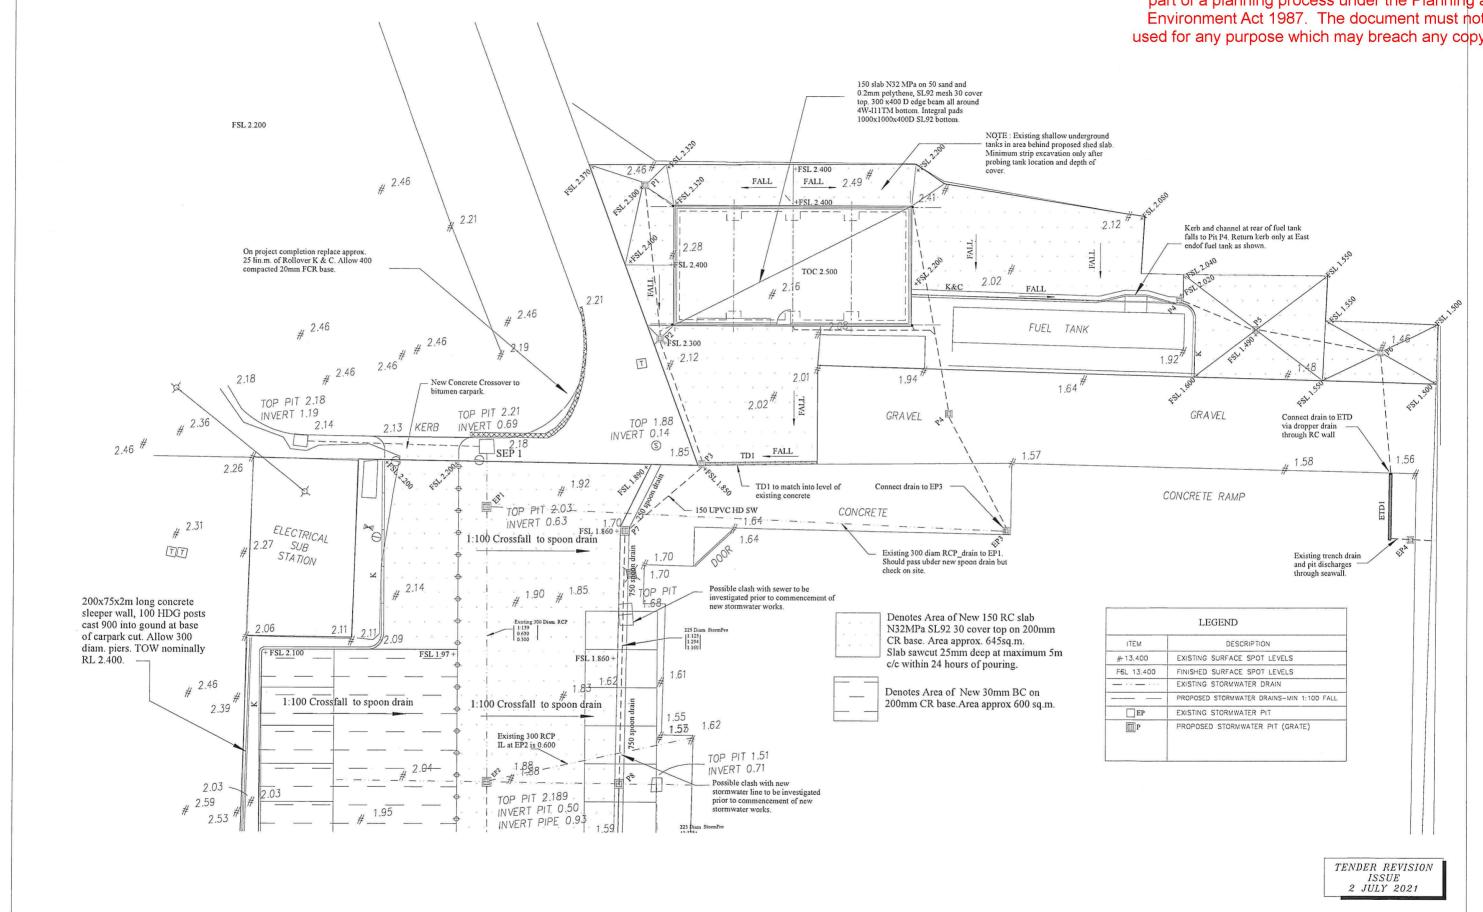

COPYRIGHT JOHN A. GARDNER & ASSOCIATES 2020 Date Commenced John Gardner & Associates LEFL SITE 19024 Loading bay S.E. comer removed from works schedule. Note to EP2 altered, N32 MPa and sawcuts note added to payement legend. N32 MPa noted to shed slab. Legend added Date Released Lakes Entrance Fisherman Ltd. JP Design Australia Pty.Ltd. Consulting Engineers | Structural & Civil 37 BULLOCK ISLAND Scale 1:100 on A1 Ph. 5977 7411 LAKES ENTRANCE Design Lakes Entrance VIC 3909 Mbl. 0417 102 153 27 The Terrace, Metung Vic 3904 Telephone 0429 646 022 email john@johngardner.com.au Email manager@lefcol.com.au Email james@jrdal.com.au Drawn SITE CIVIL PLAN - NORTHERN SECTION Checked


This copied document is made available for the sole purpose of enabling its consideration and review as part of a planning process under the Planning and R12 tie Figsvir connect Act 1987. The document must not be for CB32d for any purpose which may breach any copyright.

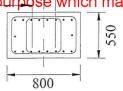

Refer to Sheet S2 for cast in ligs for CB1 and CB6




tom corbel. (typical all corbels) actural non shrink grout min. 40 Nout prior to installing planks

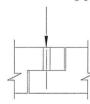

CORBEL DOWELL DETAIL

SCALE 1:2

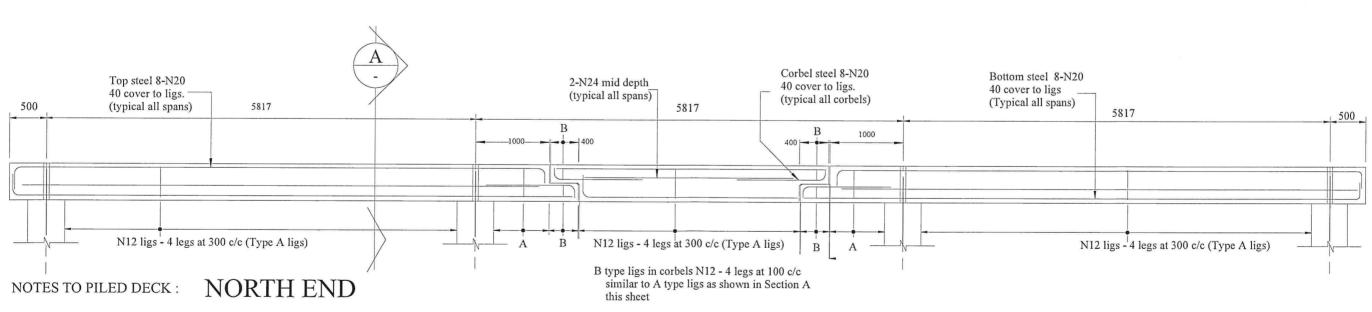

Deck planks to North side

& R10 ligs @ 400 C/C.

have a 250W x 330D upstand kerb. 2-N16 top & bottom

- 1. All concrete N50 MPa to a marine grade mix.
- 2. All reinforcement to be hot dip galvanised
- 3. RW1 by Civil Contractor

RAMP MAX 1:40

Allow PVC pipe ducts for passing

cog 300.

services through as co-ordinated
on site. Refer Electrical and Hydraulic

250 retaining wall N40 MPa RL 1018 vertical 40 cover __ each face, main bars vertical

outer face N16 starter bars

each face, 200c/c lap 800

SF1

RW1

1150

SECTION

- 4. Steel framed entry deck by cafe builder
- 5. Cafe screed and external Treadwell grid mesh by cafe builder.
- 6. Silt bags by Civil Contractor

PRECAST BEAMS CB1,2,5 & 6

3000

12 end plate 6 cfw 4-M16 chemsets into plank kerb

Allow 1metre wide filled silt

bags along toe of rock seawall

for width of cafe platform plus 1 metre each end

(typical)

Existing seawall to remain

RL 0.700

ENTRY RAMP DETAIL

DB3

SCALE 1:25

DJ - Deck Joists max, 600 c/c

DB1

30 Non Shrink levelling grout 2 - M16 S/S chemset bolts

to retaining wall - 50 slots to UB.

Strip footing N40MPa N16 @ 200 c/c top and bottom each way - 50 cover.

flush on top with DB1 and DB2 beams 8 plate cleats 6 cfw 2-M12 8.8/S


ESL approx 1.400

NOTE: Deck beams are cast as a 3 part assembly with a corbelled infill central span. Allow 15mm end to end tolerance gap each end of centre span


TENDER REVISION ISSUE 13 JULY 2021


	16								COPTRIGHT JUHN A.	GARDINER & ASSUCIAT	1ES 20201
Revision		Inentation	Client	Architects			Job title		Date Commenced	Joh No	
Rev Date Summary	BY	PROJECT			5000	John Gardner & Associates		I DEL CIPE	Date Commenced		
A 18.3.2021 Notes to precast beams to be a 3 part assembly with corbelled central spa	an JAG	NORTH			(6.3)			LEFL SITE	Date Released	= 1902) 1
B 15.6.21 Concrete Beam reo. & depth altered	JAG		Lakes Entrance Fisherman Ltd.	JP Design Australia Pty.Ltd.		Consulting Engineers Structural & Civil		37 BULLOCK ISLAND		- 1902	Z 4
C 28.6.21 Corbel reo note added	JAG		37 Bullock Island	Ph. 5977 7411				LAKES ENTRANCE	Scale		1
D 13.7.2021 Ramp gradient altered	JAG		Lakes Entrance VIC 3909	Mbl. 0417 102 153	AGSSVA	27 The Terrace, Metung Vic 3904		LAKES ENTRANCE	Design	. Drawing No.	Rev.
		X	Email manager@lefcol.com.au	Email james@jrdal.com.au	Association of Consulting Structure	Telephone 0429 646 022	Drawing title		Drawn	\sim S10	D
					Engineers Victoria.	email john@johngardner.com.au		PILED DECK & ENTRY RAMP DETAILS	-	-010	ע
		1					1		Checked		

This copied document is made available for the sole purpose of enabling its consideration and review as part of a planning process under the Planning and Environment Act 1987. The document must not be used for any purpose which may breach any copyright.

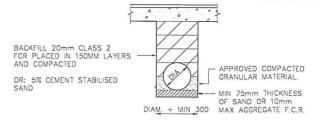

BACKFILL UNDER PAVEMENTS

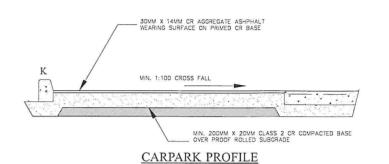


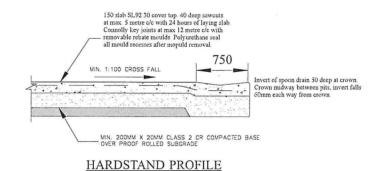

TENDER REVISION ISSUE 2 JULY 2021

COPYRIGHT JOHN A. GARDNER & ASSOCIATES 202

Date Commenced LEFL SITE 19024 Date Released 37 BULLOCK ISLAND Scale As Noted LAKES ENTRANCE Design Drawn Checked

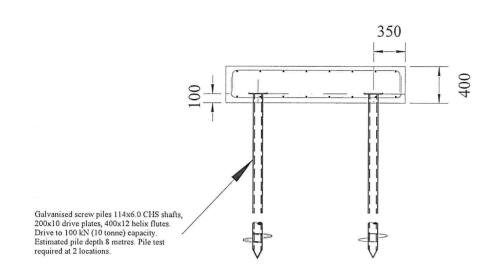

TYPICAL RAMP FOOTING DETAILS

| Revision | Rev | Date | Summary | A | 18.3.2021 | Sections 1 & 2 removed from works schedule

Lakes Entrance Fisherman Ltd. 37 Bullock Island Lakes Entrance VIC 3909 Email manager@lefcol.com.au JP Design Australia Pty.Ltd. Ph. 5977 7411 Mbl. 0417 102 153 Email james@jrdal.com.au

Architects



John Gardner & Associates Consulting Engineers | Structural & Civil

27 The Terrace, Metung Vic 3904 Telephone 0429 646 022 email john@johngardner.com.au

1	Drawing to

ring title	
	CIVIL DETAILS DETAILS

ADVERTISED This copied document is made available for the sole purpose of enabling its consideration and review as part of a planning process under the Planning and Environment Act 1987. The document must not be used for any purpose which may breach any copyright. Handrail with kerb to meet the requirements of AS1481.1. 8 base plate 6cfw to baluster Top of ST1 beyond. Connection to headstock as detailed above PF1 2-M12 8.8/S bolts thru stringer top flange @ 1000 c/c. All handrail to be HDG. Refer to Archs details for detail. ST1 ST2 ST2 ST1 , o. r 10 plate cleat 6cfw to P1 post 2-M20 8.8/S . Typical all ST2 All headstocks 8cfw to Cut down top of ST1 to pass under decking. Reinfoce with a 75x8 x 400 substitute flange 6cfw top & bott. Typical TB1 deck support trimmers 6 cfw to stringers @ max. 600 c/c. Typical P1 posts. Typical except grids 17,18,20 & 21 10 plate 6 cfw to headstock. 2-M20 8.8/S bolts to web of ST1. Typical all headstock to ST1. P1 12 base plate 8 cfw to posts. 4 off - M20 8.8/S bolt cage cast 275 into footings P₁ P1 P1 P1 110 threaded projectiont. 25mm non shrink levelling grout. Typical all P1,P2 & P3 posts PF2 PF1 **SECTION** Notes: Grids 14 to 21 - Diagonal braces 90x90x6 angle. Lateral brace at mid height 100x100x6 angle. All cleats 8 plate 6cfw to posts, 2- M20 8.8/s Notes: Grids 7 to 13 - Diagonal braces 75x75x6 angle. Lateral brace at mid height 90x90x6 angle. All cleats 8 plate 6cfw to posts, 1- M20 8.8/s bolts each end of each brace. bolts each end of each brace Viewing deck level RL 4.891 Entry deck level RL 2.300 7 8 9 10 11 14 15 16 17 18 19 20 21 Ramp Longitudinal bracing North & South faces Mid ht. lateral : Grids 12 & 13 75x75x6 SHS 8cfw to P1 posts. Handrail with kerb to meet the requirements Mid ht. lateral : Grids 17,18,20 & 21 of AS1481.1. 8 base plate 6cfw to baluster 2-M12 4.6/S bolts thru stringer top flange @ 1000 c/c. All handrail to be HDG. Grids 14 & 15 90x90x6 SHS 8 cfw to P2 posts. **SECTION SECTION** Denotes Treadwell GTX 381919 FRP gritted decking fixed with mushroom washer S/S fixings at max 375 c/c to TA1 angle support joists (not shown for clarity). ⊒ DB3 10 end plate 6cfw to DB1, 2-M20 4.6/S 12 plate 8cfw to DB3 & P3 4 - M20 8.8/S Typical DB3 to P3 field con TENDER REVISION DETAIL ISSUE 2 JULY 2021 COPYRIGHT JOHN A. GARDNER & ASSOCIATES 202 Revision
Rev Date Summary Date Commenced BY John Gardner & Associates LEFL SITE 19024 Date Released Consulting Engineers | Structural & Civil 37 BULLOCK ISLAND Lakes Entrance Fisherman Ltd. JP Design Australia Pty.Ltd. Scale As Noted Ph. 5977 7411 37 Bullock Island LAKES ENTRANCE

27 The Terrace, Metung Vic 3904 Telephone 0429 646 022

email john@johngardner.com.au

Lakes Entrance VIC 3909

Email manager@lefcol.com.au

Mbl. 0417 102 153

Email james@jrdal.com.au

JAG Drawing No.


JAG


Drawn

VIEWING DECK AND RAMP DETAILS

S12

This copied document is made available for the sole purpose of enabling its consideration and review as part of a planning process under the Planning and Environment Act 1987. The document must not be used for any purpose which may breach any copyright.

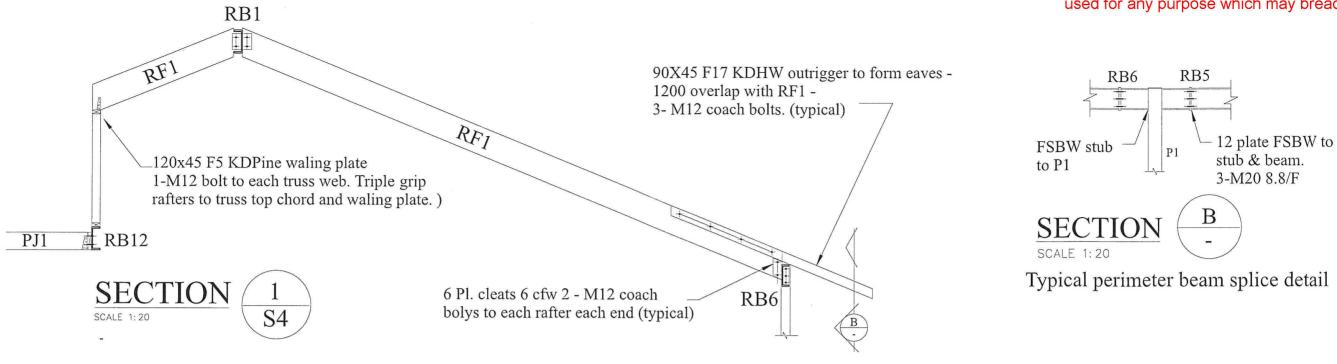

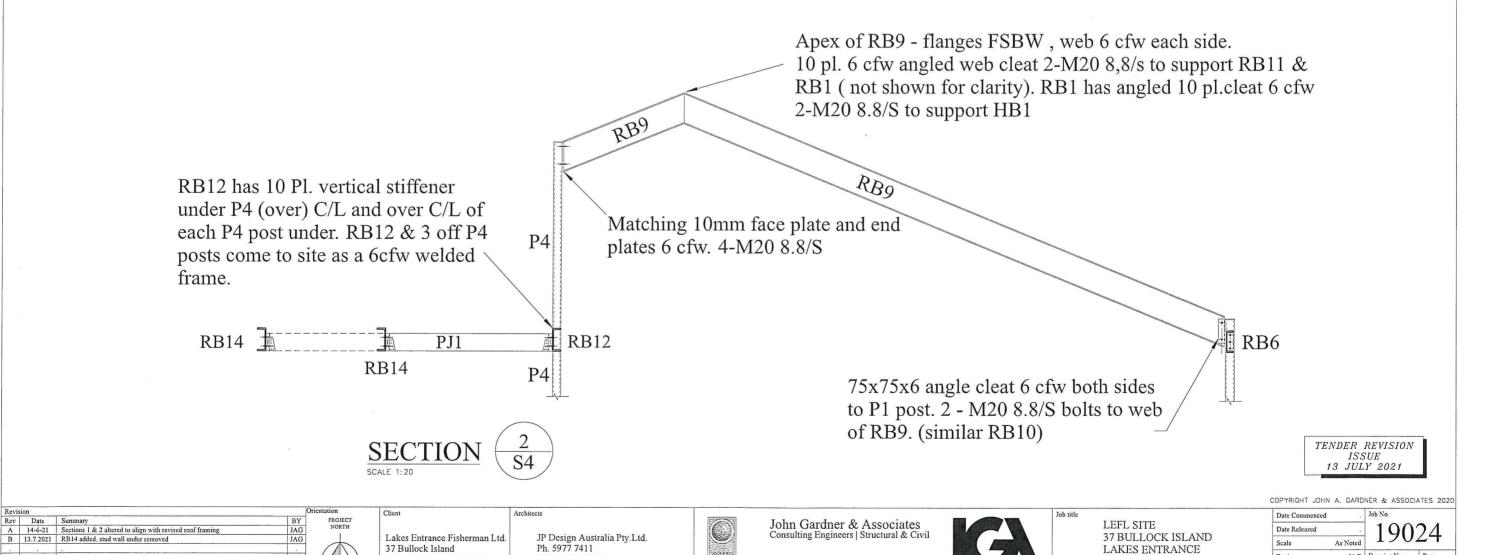

27 The Terrace, Metung Vic 3904 Telephone 0429 646 022

email john@johngardner.com.au

Lakes Entrance VIC 3909

Email manager@lefcol.com.au

Mbl. 0417 102 153

Email james@jrdal.com.au


CAFE ROOF DETAILS

This copied document is made available for the sole purpose of enabling its consideration and review as part of a planning process under the Planning and Environment Act 1987. The document must not be used for any purpose which may breach any copyright.




NOTES: Building in a high wind load aerea. Special attention to be paid to tying down all roof members with hoop iron straps, cyclone batten straps, fully nailed joist hangers, triple grips. Top plates of walls to have cyclone stud straps every second stud.

60 diam. corrugated metal grout tubehole for N24 shear pin 400 long cast 200 into bottom corbel. (typical all corbels) Structural non shrink grout min. 40 MPa. Grout prior to installing planks

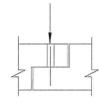


CORBEL DOWELL DETAIL

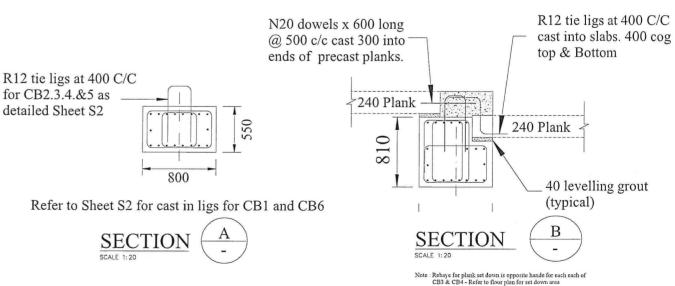


TENDER REVISION ISSUE 13 JULY 2021

COPYRIGHT JOHN A. GARDNER & ASSOCIATES 2020

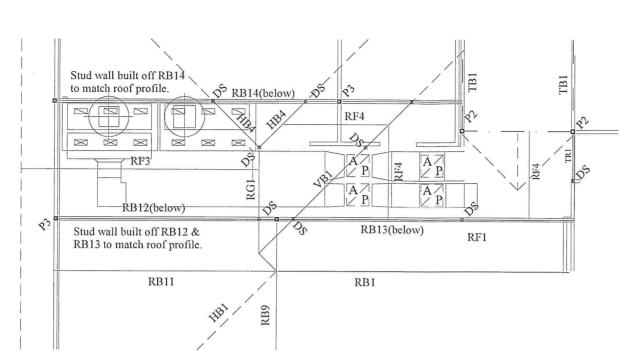

FREE FRAMED ROOF ABOVE PLANT PLATFORM

SCALE 1:50

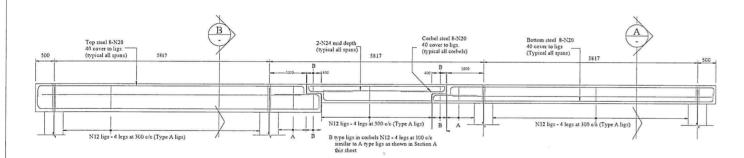

PLATFORM BEAMS CB3&4 ELEVATION

SCALE 1:50



37 Bullock Island

Lakes Entrance Fisherman Ltd. Lakes Entrance VIC 3909 Email manager@lefcol.com.au

JP Design Australia Pty.Ltd. Ph. 5977 7411 Mbl. 0417 102 153 Email james@jrdal.com.au

John Gardner & Associates Consulting Engineers | Structural & Civi

27 The Terrace, Metung Vic 3904 Telephone 0429 646 022 email john@johngardner.com.au

for CB2.3.4.&5 as

detailed Sheet S2

il	


Drawing title Free Framed roof above plant platform
37 BULLOCK ISLAND LAKES ENTRANCE
Job title LEFL SITE

Date Commenced Date Released Design Drawn

This copied document is made available for the sole purpose of enabling its consideration and review as Environment Act 1987. The document must not be used for any purpose which may breach any copyright.

Off The Wharf Café: Bar & Storage Shed part of a planning process under the Planning and

A poor example of what the shed would look like

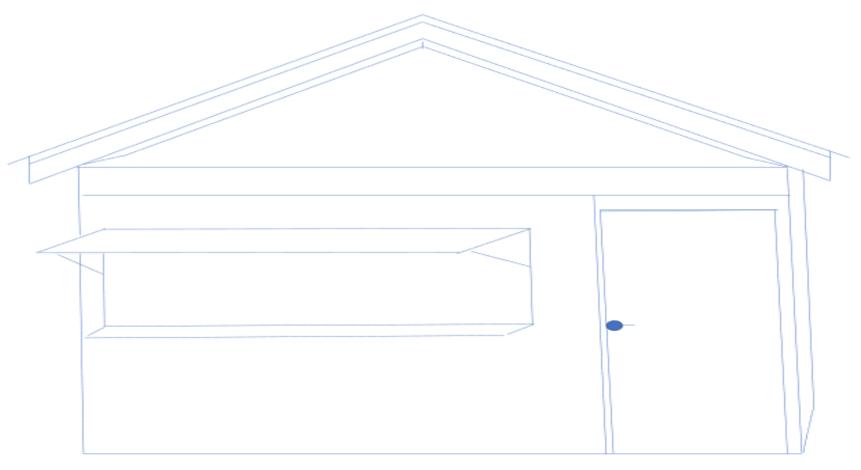

Measurements: Walls- 3200mm x 3200mm Internal ceiling height-2450mm Roof pitch roof 18 degree Building materials- Corrugated roofing iron, Hardwood exterior cladding 150mm x 25mm & corrugated iron cladding on wall sections. Electricity will be connected for lights and power. Plumbing- Hot and cold water supply & plumbing waste for the basin. Standard bench heights made of hardwood, flooring will be artificial grass carpet over the mess floor.

Timber for wall frames 90mm x 45mm Pine . Rafters 130mm x 45mm- Spaced .700mm apart. Timber roof battens (90mm X 35mm)


This copied document is made available for the sole purpose of enabling its consideration and review as Environment Act 1987. The document must not be used for any purpose which may breach any copyright.

Off The Wharf Café: Bar & Storage Shed part of a planning process under the Planning and

A poor example of what the shed would look like

Bar/Storage Plan 3200mm Storage area Storage Basin 3200mm Bar bench Top 880 mm Outdoor bench-Top The outside awning will have 2 struts attached to open and close. $\, \diamondsuit \,$

This copied document is made available for the sole purpose of enabling its consideration and review as Off The Wharf Café: Bar & Storage Shed part of a planning process under the Planning and Environment Act 1987. The document must not be

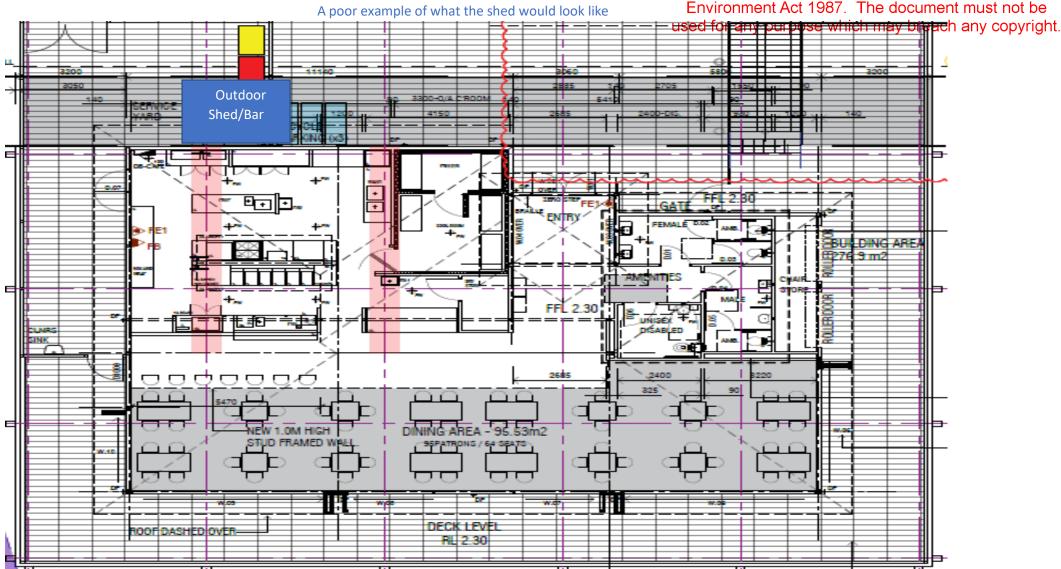

This copied document is made available for the sole purpose of enabling its consideration and review as Off The Wharf Café: Bar & Storage Shed part of a planning process under the Planning and Environment Act 1987. The document must not be used for any purpose which may breach any copyright.

A poor example of what the shed would look like Proposed Location of the building

The building will be designed as a beach shack, it will have fake doors at the front



- A section of the fenced service yard will be removed to accommodate the build.
- The Bar is facing Easterly.

