Website www.eastgippsland.vic.gov.au Email feedback@egipps.vic.gov.au Follow us on Twitter @egsc

This copied document is made available for the sole purpose of enabling its consideration and review as part of a planning process the Planning and Environment Act 1987 in the document must not be used for any purpose which may breach any copyright.

Amend a Planning Permit Application

Applicant details:		
Applicant name: Saw Caracalla		
Business trading name (if applicable):		
Email addres		
Postal address: 17 KINGFISHER PLACE		
SOUTH MORANG		Postcode 3752
Phone number: Home: Work:	Mobile	
Owners details (if not the applicant):		
Name: SIAN CARACEUA		
Business trading name (if applicable):	a MANAG	SEMENT LID
Email addres		
Postal address: 17 KINGFISHER PLACE		
SOUTH MORANG		Postcode 3752
Phone number: Home: Work:	Mobile	· ·
Property details:		
Street number: 6 Street name: HAKEA	COURT	
Town: MALLACOOTA		Postcode J892
Lot Number: \ \ \ \ \ \ \ \ \ \ \ \ \ \ \ \ \ \ \	Subdivision	Number: 6
Crown allotment number:	Section numb	per:
arish/Township name: MALLACOCTA		
anning permit number to be amended:		
our reference number:		
nere any encumbrance on the Title such as a restrictive covenar ement or other obligation such as an easement or building enve		☐ Yes ☑ No
he proposal result in a breach of a registered covenant restrict ement?	ion or	☐ Yes ☑ N

Is agi

Will agre

he East Gippsland Shire Council asks for details about you to collect rates, approve permits and licences, and run a range of community services. The information you ive to us on this form is used only for the reasons set out in the form and is not given to anybody else. Sometimes we may supply details about you to someone else, but

ily if we are allowed by law, or to protect someone or property. then information is given out, Council will always try to make sure your privacy is protected in line with the Privacy and Deta Protection Act 2014. You may ask for more primation about Council's Privacy Policy by contacting our Information Privacy Officer on 03 5153 9500 or e-mail feedback@egipps.vic.gov.au

Oct 2024

Bairnsdale VIC 3875 Website www.eastgippsland.vic.gov.au Email feedback@egipps.vic.gov.au Follow us on Twitter @egsc

ADVERTISED

This copied document is made available for the sole purpose of enabling its consideration and review as part of a planning process under the Planning and Environment Act 1987. The document must not be used for any nurnose which may breach any

DOGGIDUGII DI SIMANAIN III	when may breach any copyright.
development): Describe the amendment being applied for (i.e.	change to conditions, change to
The state of the s	
T.SM THE OVERALL FINISH HELD	SHE THE
-1.3M	
Entimated diff	
Estimated difference in cost of development because of the amendment. Note: You may need to verify this estimate	\$
W	
If you need more space or have more information, please attach with this for	orm.
Please make sure that:	
Form is filled in fully and signed	
☐ The correct fee is paid or payment enclosed	
☐ Attached any supporting information or documents	
Covenants/agreements Site Plan floor plan/alevations	
 Site Plan - floor plan/elevations Planning report 	
 Supporting information/reports (e.g. – Land Capability Assessment, B Geotechnical report/waiver) 	ushfire Management Statement,
This application has associated costs that will be determined by a to-	wn planner
Tho is the invoice to be made out to? San Caraceu	A

he East Gippsland Shire Council asks for details about you to collect rates, approve permits and licences, and run a range of community services. The information we to us on this form is used only for the reasons set out in the form and is not given to anybody else. Sometimes we may supply details about you to someonly if we are allowed by law, or to protect someone or property.

Printed 6/02/2025

The may supply details about you to someone or property.

Printed 6/02/2025

The may supply details about you to someone or property.

Project Information

Job No. 0999 Town Planning Ver.03 (A3 Sheet Size - To Scale) Date 23/01/25

ADVERTISED

This copied document is made wailable for the sole purpose of enabling its consideration and review as part of a planning process planning the process planning and Environment Act 1987. The document must not be used for any purpose which may breach any copyright.

PROPOSED DWELLING

At: 6 Hakea Crescent, Mallacoota VIC 3892 For: Sean Caracella



LMD Design & Drafting Pty Ltd

This copied document is made available for the sole purpose of enabling its consideration and review as part of a planning process under the Planning and Environment Act 1987. The document must not be used for any purpose which may breach any copyright.

TOWN PLANNING DRAWINGS

TP01 - Neighborhood and Site Description

TP02 - Proposed Site/Roof Plan (Outer) Defendable Space - 25m

TP03 - Proposed Site/Roof Plan

TP04 - Design Response / Garage Ground Floor Plan

TP05 - Design Response / First Floor Plan

TP06 - Proposed Garage Ground Floor Plan

TP07 - Proposed First Floor Plan

TP08 - Proposed Elevations

TP09 - Proposed Elevations

TP10 - Proposed Site / Shadow Diagram 9am, 12pm & 3pm

TP11 - Bal 29 Notes

REVI	<u>SIONS</u>		
REV.	DESCRIPTION	BY	DATE

©	This drawing & design must not be copied in part or v the written authorisation from LMD Design & Drafting	

Ver.02 Town Planning	GENERAL NOTES -
voi.oz rowii i lailiilig	Do not scale drawings, use written
	dimensions only. These drawings are
OCUMENTATION ISSUE	to be read in conjunction with
	stamped town planning drawings and

PLANNING (NOT FOR CONSTRUCTION) PRELIMINARY (NOT FOR CONSTRUCTION) TENDER (NOT FOR CONSTRUCTION)

CONSTRUCTION

Check and verify all dimensions and details on site prior to the commencement of any works, and report any discrepancies or anomalies


to the office of LMD Design & drafting for clarification.

These drawings are neither exhaustive or a substitute for regulations, all engineering documentation where statutory requirements, building practice or contractual obligations, and unless expressly stated otherwise. These notes are provided only as guidelines. No responsibility is accepted for their use

JOB NO 0999	DRAWN BY - LD	SCALE -	SHEET SIZE - A3	DRAWING NO	DATE - 19/09/2024
ADDRESS 6 Hakea Cour		FOR - Sean Caracell	а	DESIGNER - LMD Design & Dra	afting Pty Ltc
VIC		DRAWING	_	BUILDER -	
PROJECT - Proposed Dwo		Contents She		TBC	



This copied document is made available for the sole purpose of enabling in the sole purpose of enabling in the sole part of a planning presented with the sole part of a planning presented by the sole province of the sole purpose of the sole purpose of enabling in the sole purpose of the sole purpose of the sole purpose of enabling in the sole purpose of the sole p used for any purpose which may breach any copyright.

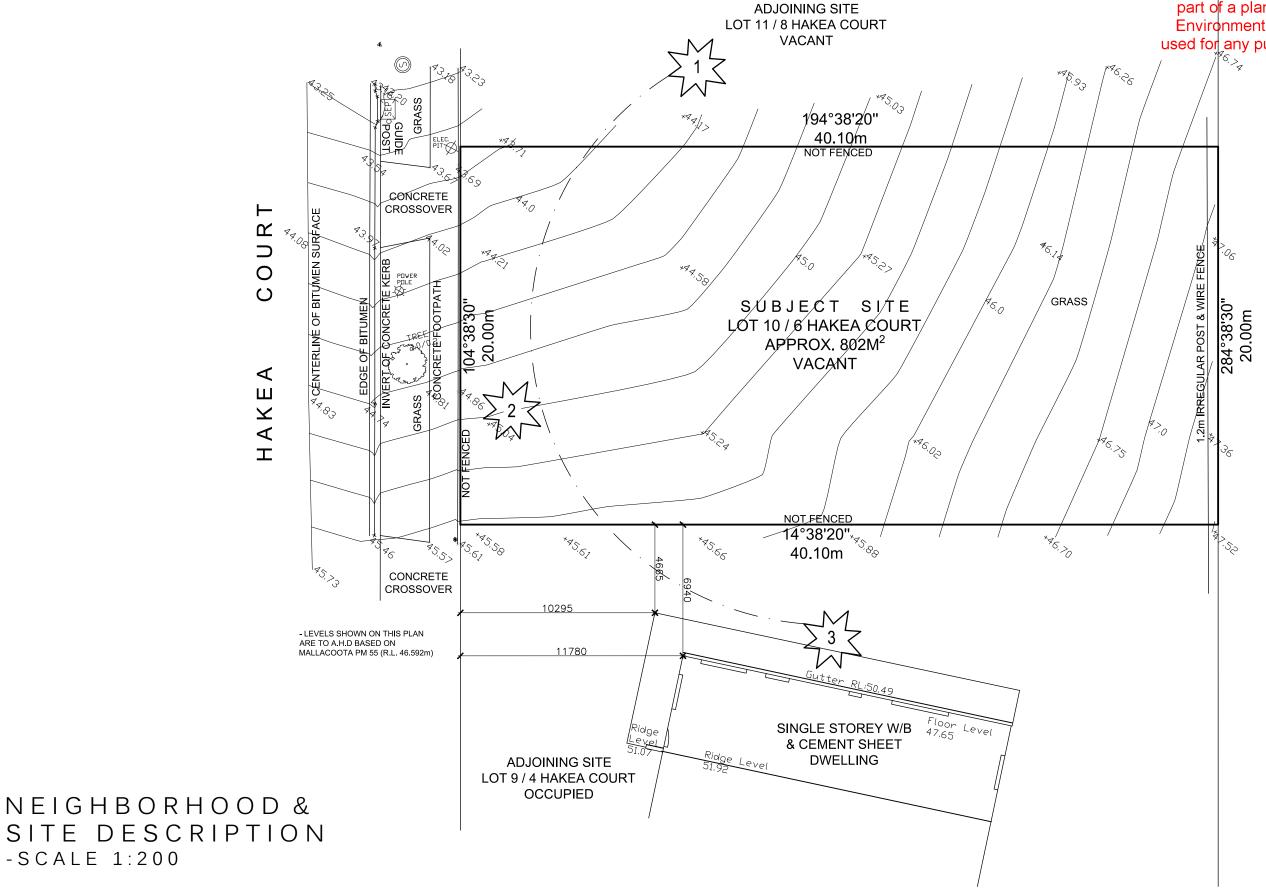

REVI	SIONS		
REV.	DESCRIPTION	BY	DATE

-SCALE 1:200

This drawing & design must not be copied in part or whole without the written authorisation from LMD Design & Drafting Pty Ltd.

Ver.02 Town Planning

DOCUMENTATION ISSUE

PLANNING (NOT FOR CONSTRUCTION) PRELIMINARY (NOT FOR CONSTRUCTION)

TENDER (NOT FOR CONSTRUCTION) CONSTRUCTION

GENERAL NOTES -

Do not scale drawings, use written dimensions only. These drawings are to be read in conjunction with stamped town planning drawings and all engineering documentation where

Check and verify all dimensions and details on site prior to the commencement of any works, and report any discrepancies or anomalies

to the office of LMD Design & drafting for clarification.

These drawings are neither exhaustive or a substitute for regulations, statutory requirements, building practice or contractual obligations, and unless expressly stated otherwise. These notes are provided only as auidelines. No responsibility is accepted for their use.

JOB NO	DRAWN BY -
0999	LD

ADDRESS -6 Hakea Court, Mallacoota

PROJECT -Proposed Dwelling

SCALE -SHEET SIZE 1:200

Neighborhood and Site

Description

TBC

FOR -

Sean Caracella DRAWING -**BUILDER** -

DATE -DRAWING NO. - TP01 19/09/2024

DESIGNER -LMD Design & Drafting Pty Ltd


NORTH

1. Sun Risers.

A: 'Regus' Lower Heidelberg Rd,
Heidelberg VIC 3084
P: 0474696795
Printed 196/02/2025

Path of Suns Travel- East to West.

This copied document is made available for the sole purpose of enabling its consideration of enabling its consideratio part of a planning process under the Planning and Environment Act 1987. The document must not be used for any purpose which may breach any copyright.

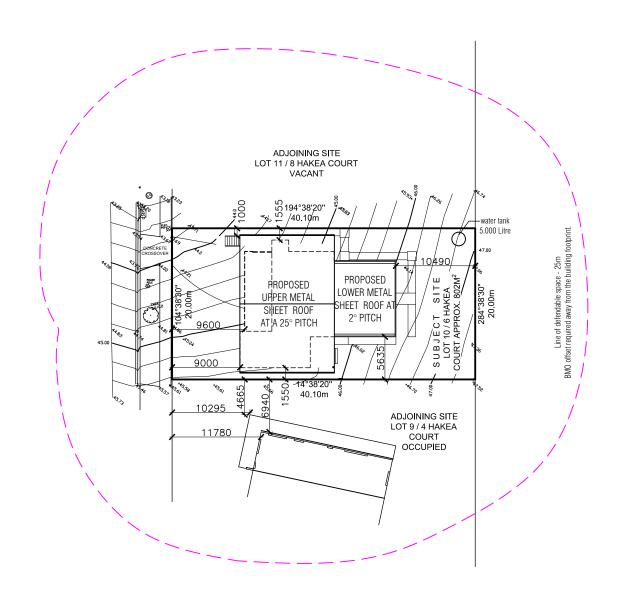

PROPOSED SITE/ROOF PLAN (OUTER) DEFENDABLE SPACE - 25M -SCALE 1:500

REVISIONS				
REV.	DESCRIPTION	BY	DATE	

This drawing & design must not be copied in part or whole without the written authorisation from LMD Design & Drafting Pty Ltd.

Ver.02 Town Planning

DOCUMENTATION ISSUE

PLANNING (NOT FOR CONSTRUCTION) PRELIMINARY (NOT FOR CONSTRUCTION)

TENDER (NOT FOR CONSTRUCTION) CONSTRUCTION

GENERAL NOTES -

Do not scale drawings, use written dimensions only. These drawings are to be read in conjunction with stamped town planning drawings and all engineering documentation where

Check and verify all dimensions and details on site prior to the commencement of any works, and report any discrepancies or anomalies

to the office of LMD Design & drafting for clarification.

These drawings are neither exhaustive or a substitute for regulations, statutory requirements, building practice or contractual obligations, and unless expressly stated otherwise. These notes are provided only as guidelines. No responsibility is accepted for their use.

JOB NO	DRAWN BY -
0999	LD

ADDRESS -6 Hakea Court, Mallacoota

PROJECT -Proposed Dwelling

SCALE -SHEET SIZE -1:500

Proposed Site/Roof Plan (Outer)

Defendable Space - 25m

FOR -

Sean Caracella

DRAWING -

DATE -DRAWING NO. - TP02 19/09/2024

DESIGNER -

LMD Design & Drafting Pty Ltd BUILDER -

TBC

NORTH

A: 'Regus' Lower Heidelberg Rd,
Heidelberg VIC 3084
P: 0474696795
Printed 196/02/2025

Page 6 of 15

Proposed Dwelling

2000 litre rain water tank. 7m(L) x 0.7m(W) x 1.86m(H) rainwater tank to be connected to all sanitry - flushing systems

area analysis:

Dwelling:

site area: 802m2 (approx.)

site coverage: 281.35m2 35.08% 432.80m2 53.96% garden area: permeability: 441.40m2 55.03%


secluded p.o.s: 338.25m2

p.o.s: 195.05m2 total p.o.s: 533.3m2

ADJOINING SITE LOT 11 / 8 HAKEA COURT

This copied document is made available for the sole purpose of enabling him with single religious and control of a planning processes and the processes are processes and the processes are processed as a planning processes and the processes are processed as a planning processes and the processes are processed as a planning processes and the processes are processed as a planning processes and the processes are processed as a planning processes and the processes are processed as a planning processes are processed as a planning processes are processed as a planning processes and the processes are processed as a planning processes are pr used for any purpose which may breach any copyright.

ADVERTISED

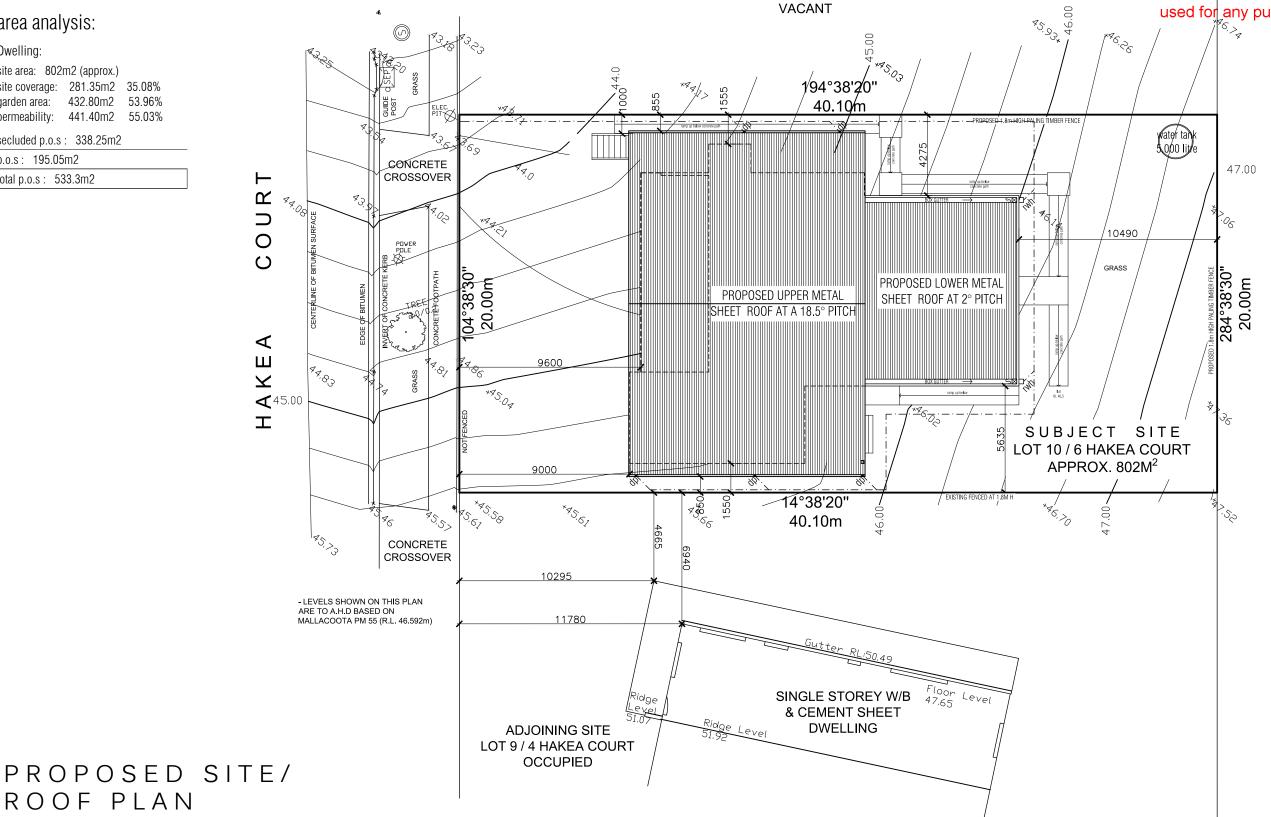

ROOF NOTES:

PROPOSED STORMWATER DRAINAGE LAYOUT AS SHOWN, WITH MIN. 100MM DIA. PVC PIPES SET MIN. 200MM BELOW SURFACE LEVEL, AT MIN. FALL TO BE CONNECTED TO EXISTING POINT OF DISCHARGE AS PER AS 3500 3 1-2018 -BUILDER/DRAINAGE CONTRACTOR TO CONFIRM SIZE, TYPE,
OFFSETS & DEPTHS OF EXISTING STORMWATER PIPES PRIOR TO

ALL ROOF STRUCTURE/S AS PER ENGINEERS DESIGN & MANUFACTURE DETAILS.

WATER TO BE CARRIED THROUGH DP'S INTO DRAINAGE SYSTEM, AND DISBURSED TO LEGAL POINT OF DISCHARGE (Typ).

SELECTED ELASHING & RIDGE CAPPING FOR WATERPROOFING REQUIREMENTS TO ALL FIXING/CONNECTION POINTS (Typ.)

PROPOSED UPPER METAL SHEET ROOF TO DWELLING (COLORBOND OR EQUALLY APPROVED) AT 25° PITCH, WITH A METAL FASCIA & METAL GUTTER.

PROPOSED LOWER METAL SHEET ROOFS TO DWELLING (KLIP-LOK OR EQUALLY) TO PORTION OF GARAGE AT A 2° FALL, WITH A PROPOSED MIN. 250MM WIDE X 100MM DEEP ZINCALUME BOX GUTTER, WITH SUMPS INSTALLED. ALL TO BE AS PER A.S. 3500.3

PROPOSED METAL SHEET ROOFS (KLIP-LOK OR EQUALLY) TO PORTION OF GARAGE AT A 2° FALL, WITH A PROPOSED MIN. 250MM WIDE X 100MM DEEP ZINCALUME BOX GUTTER, WITH SUMPS INSTALLED. ALL TO BE AS PER A.S. 3500.3 - 2018.

SELECTED RAINWATER TANK TO PROPOSED DWELLING AND TO BE INSTALLED IN STRICT ACCORDANCE WITH MANUFACTURERS
DETAILS AND SPECIFICATIONS. TANK TO BE CONNECTED TO ALL SANITARY FLUSHING SYSTEMS. TANK TO BE FITTED WITH OVERFLOW SYSTEM CONNECTED TO STORMWATER SYSTEM AND TAKEN TO LEGAL POINT OF DISCHARGE TO THE SATISFACTION OF THE LOCAL AND GOVERNING AUTHORITIES. WATER TANK TO BE

-LOCATION TO BE CONFIRMED ON SITE.

REVISIONS REV. DESCRIPTION BY DATE

ROOF PLAN

-SCALE 1:200

This drawing & design must not be copied in part or whole without the written authorisation from LMD Design & Drafting Pty Ltd.

Ver.02 Town Planning

DOCUMENTATION ISSUE

PLANNING (NOT FOR CONSTRUCTION) PRELIMINARY (NOT FOR CONSTRUCTION)

TENDER (NOT FOR CONSTRUCTION) CONSTRUCTION

GENERAL NOTES -

Do not scale drawings, use written dimensions only. These drawings are to be read in conjunction with stamped town planning drawings and all engineering documentation where

Check and verify all dimensions and details on site prior to the commencement of any works, and report any discrepancies or anomalies to the office of LMD Design & drafting for clarification.

These drawings are neither exhaustive or a substitute for regulations, statutory requirements, building practice or contractual obligations, and unless expressly stated otherwise. These notes are provided only as auidelines. No responsibility is accepted for their use.

I I	-
0999 LD	

ADDRESS -6 Hakea Court, Mallacoota

PROJECT -Proposed Dwelling

SCALE -SHEET SIZE DRAWING DATE -NO. - TP03 1:200 19/09/2024 FOR -**DESIGNER** -LMD Design & Drafting Pty Ltd Sean Caracella **DRAWING** -**BUILDER** -Proposed Site/Roof Plan TBC

NORTH



A: 'Regus' Lower Heidelberg Rd, Heidelberg VIC 3084 Printed 06/02/2025 Proposed Dwelling

2000 litre rain water tank. 7m(L) x 0.7m(W) x 1.86m(H) rainwater tank to be connected to all sanitry - flushing systems

area analysis:

Dwelling:

site area: 802m2 (approx.) site coverage: 281.35m2 35.08%


432.80m2 53.96% garden area: 441.40m2 55.03%

secluded p.o.s: 338.25m2

p.o.s: 195.05m2 total p.o.s: 533.3m2

ADVERTISED

This copied document is made available for the sole purpose of enabling imensions identified and review as part of a planning presented the training presented the property of a planning presented the property of a planning presented the property of a planning presented the property of the document must not be used for any purpose which may breach any copyright.

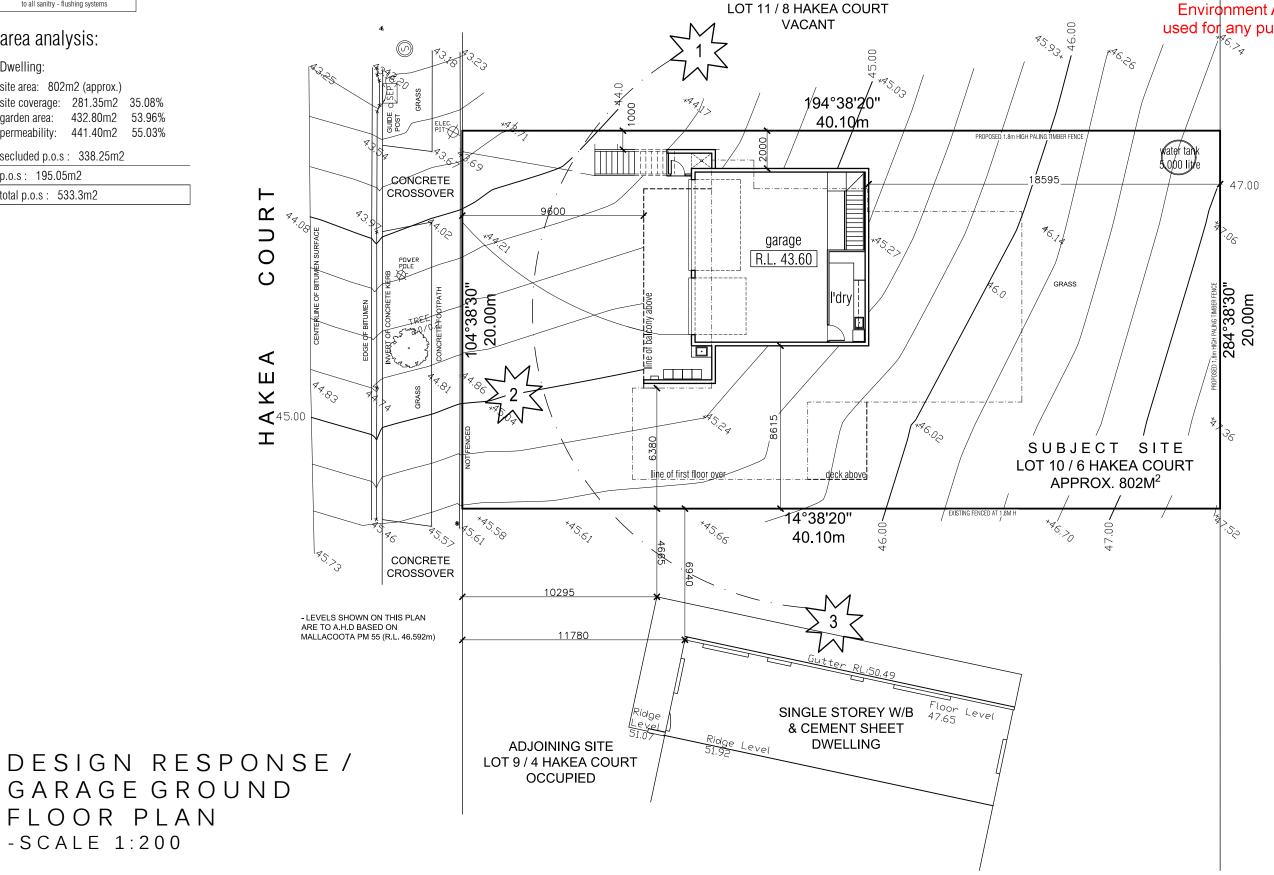

ADJOINING SITE

REVISIONS REV. DESCRIPTION BY DATE

FLOOR PLAN

-SCALE 1:200

(C) This drawing & design must not be copied in part or whole without the written authorisation from LMD Design & Drafting Pty Ltd.

Ver.02 Town Planning

DOCUMENTATION ISSUE

PLANNING (NOT FOR CONSTRUCTION)

PRELIMINARY (NOT FOR CONSTRUCTION) TENDER (NOT FOR CONSTRUCTION)

CONSTRUCTION

GENERAL NOTES -

Do not scale drawings, use written dimensions only. These drawings are to be read in conjunction with stamped town planning drawings and all engineering documentation where

Check and verify all dimensions and details on site prior to the commencement of any works, and report any discrepancies or anomalies

to the office of LMD Design & drafting for clarification.

These drawings are neither exhaustive or a substitute for regulations, statutory requirements, building practice or contractual obligations, and unless expressly stated otherwise. These notes are provided only as auidelines. No responsibility is accepted for their use

JOB NO	DRAWN BY -
0999	LD

ADDRESS -6 Hakea Court, Mallacoota

PROJECT -Proposed Dwelling

SCALE -SHEET SIZE DRAWING NO. - TP04 1:200 DESIGNER -FOR -Sean Caracella **BUILDER** -DRAWING -

Design Response / Garage

Ground Floor Plan

DATE -19/09/2024

LMD Design & Drafting Pty Ltd

TBC


NORTH

1. Sun Risers.


<u>A</u>: 'Regus' Lower Heidelberg Rd, Heidelberg VIC 3084

Printed 6/02/2025

Path of Suns Travel- East to West.

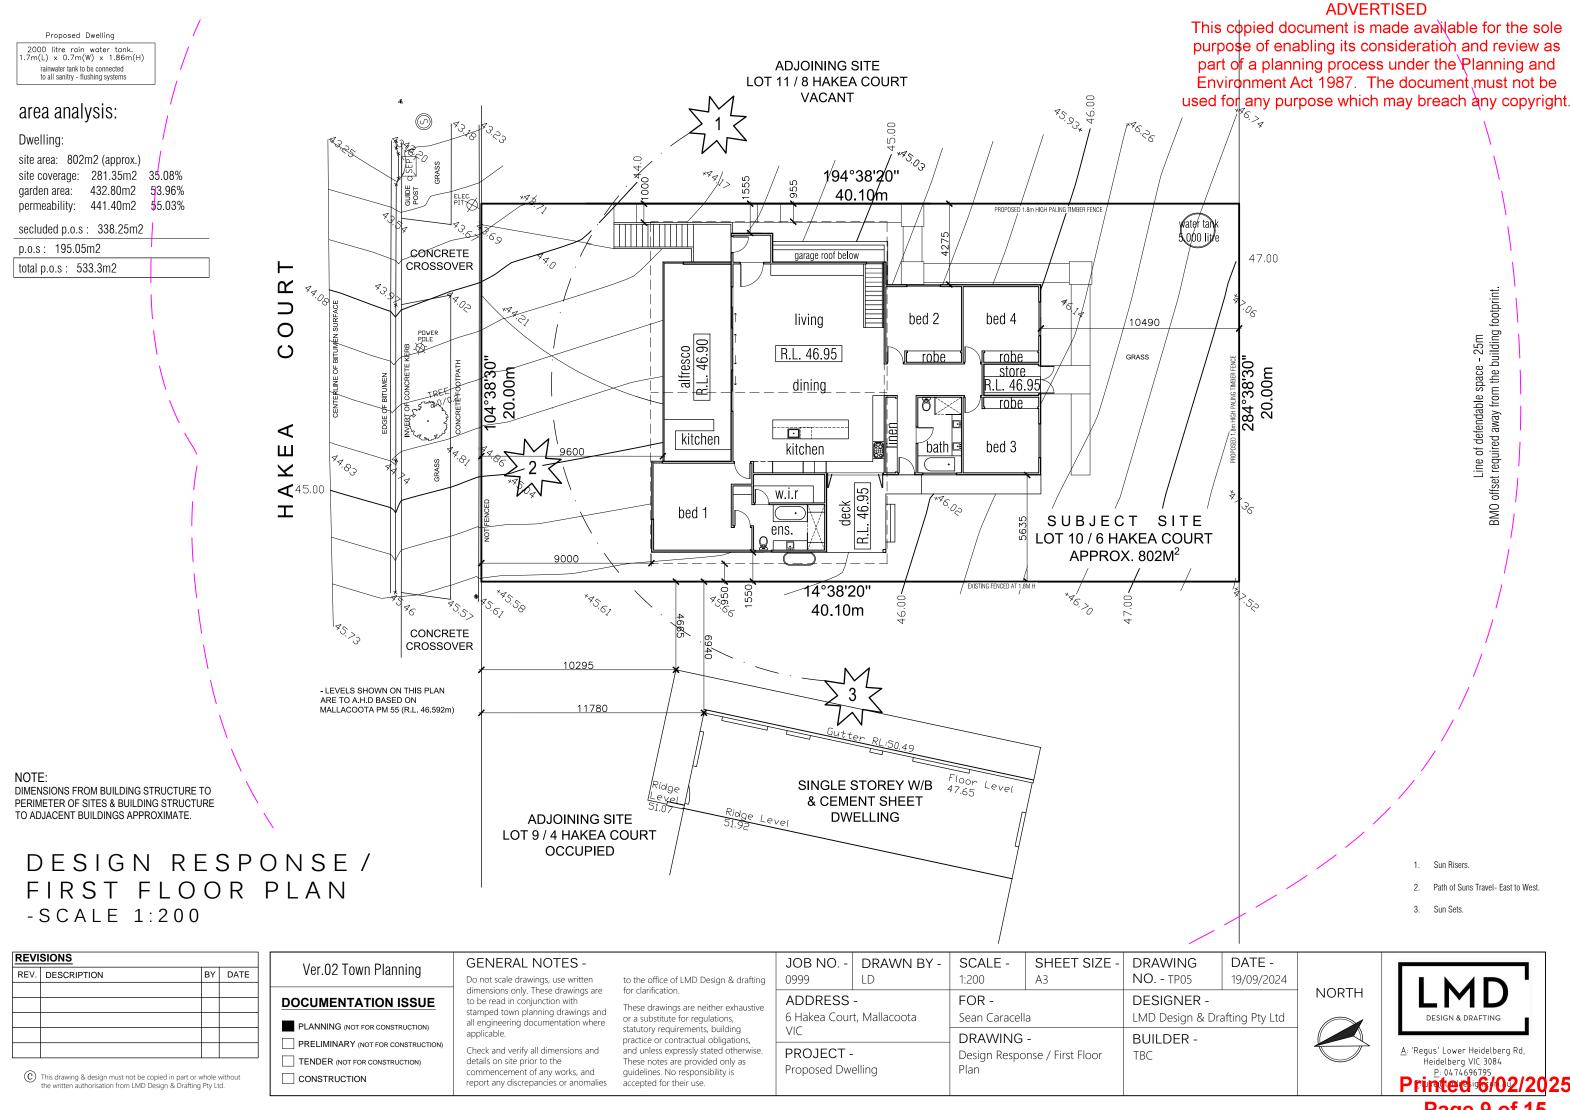

This copied document is made available for the sole purpose of enabling its consideration and review as part of a planning process under the Planning and Environment Act 1987. The document must not be used for any purpose which may breach any copyright.

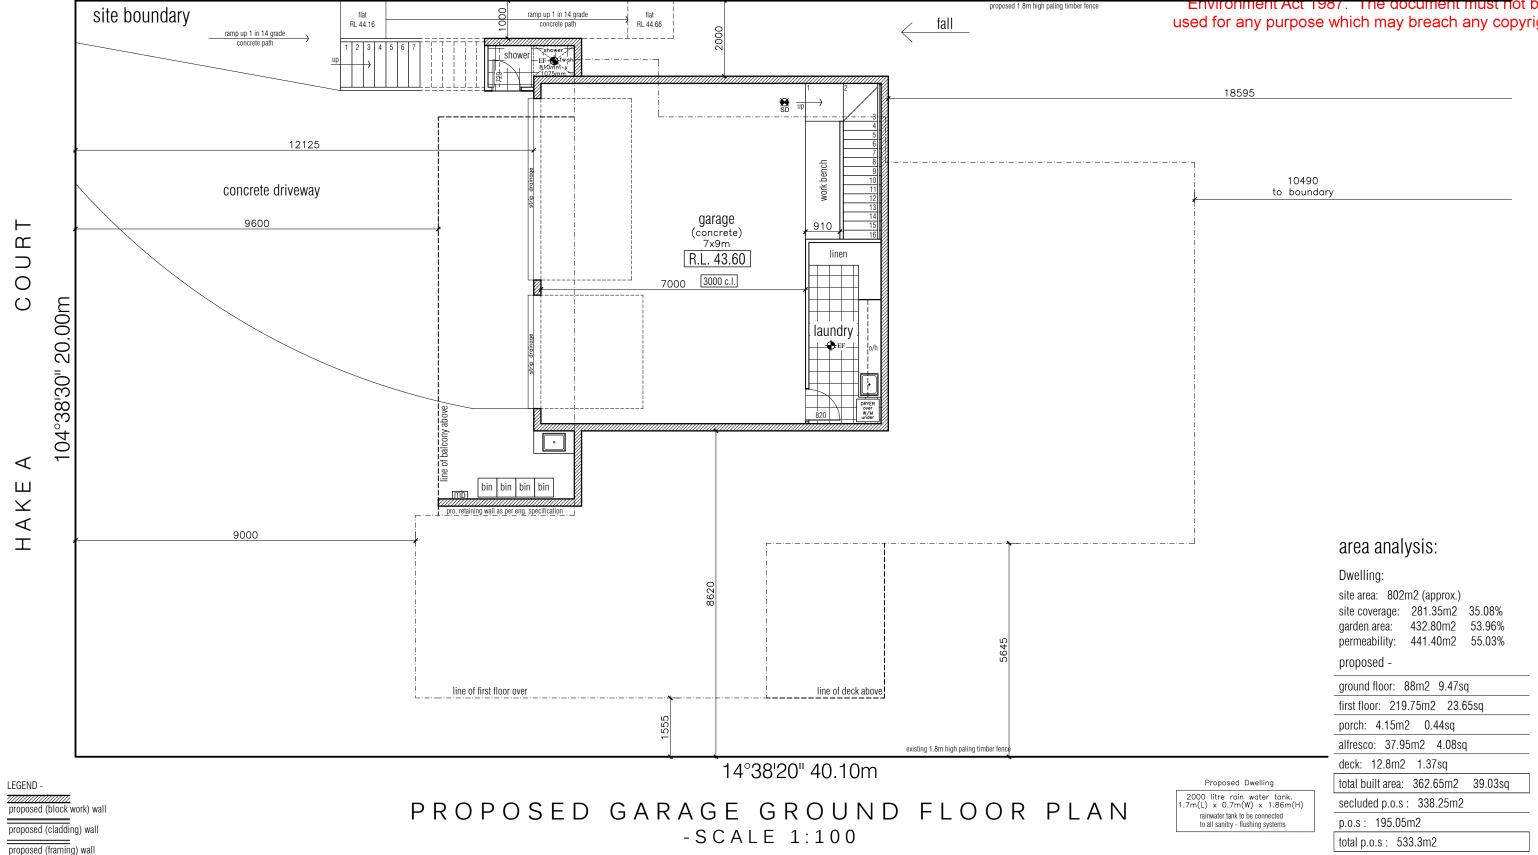

194°38'20" 40.10m

REVISIONS					
REV.	DESCRIPTION	BY	DATE		

This drawing & design must not be copied in part or whole without the written authorisation from LMD Design & Drafting Pty Ltd.

Ver.02 Town Planning

DOCUMENTATION ISSUE

PLANNING (NOT FOR CONSTRUCTION) PRELIMINARY (NOT FOR CONSTRUCTION)

TENDER (NOT FOR CONSTRUCTION) CONSTRUCTION

GENERAL NOTES -

Do not scale drawings, use written dimensions only. These drawings are to be read in conjunction with stamped town planning drawings and all engineering documentation where

Check and verify all dimensions and details on site prior to the commencement of any works, and report any discrepancies or anomalies

to the office of LMD Design & drafting for clarification.

These drawings are neither exhaustive or a substitute for regulations, statutory requirements, building practice or contractual obligations, and unless expressly stated otherwise. These notes are provided only as auidelines. No responsibility is accepted for their use

JOB NO	DRAWN BY -
0999	LD

1:100

FOR -

DRAWING -

Floor Plan

Proposed Garage Ground

ADDRESS -6 Hakea Court, Mallacoota

PROJECT -

Proposed Dwelling

SCALE -SHEET SIZE DRAWING Sean Caracella

LMD Design & Drafting Pty Ltd

NO. - TP06 DESIGNER -

BUILDER -

TBC

DATE -

19/09/2024


NORTH

A: 'Regus' Lower Heidelberg Rd,
Heidelberg VIC 3084
P: 0474696795
Printed: 6/02/2025

Page 10 of 15

This copied document is made available for the sole purpose of enabling its consideration and review as part of a planning process under the Planning and Environment Act 1987. The document must not be used for any purpose which may breach any copyright.

194°38'20" 40.10m

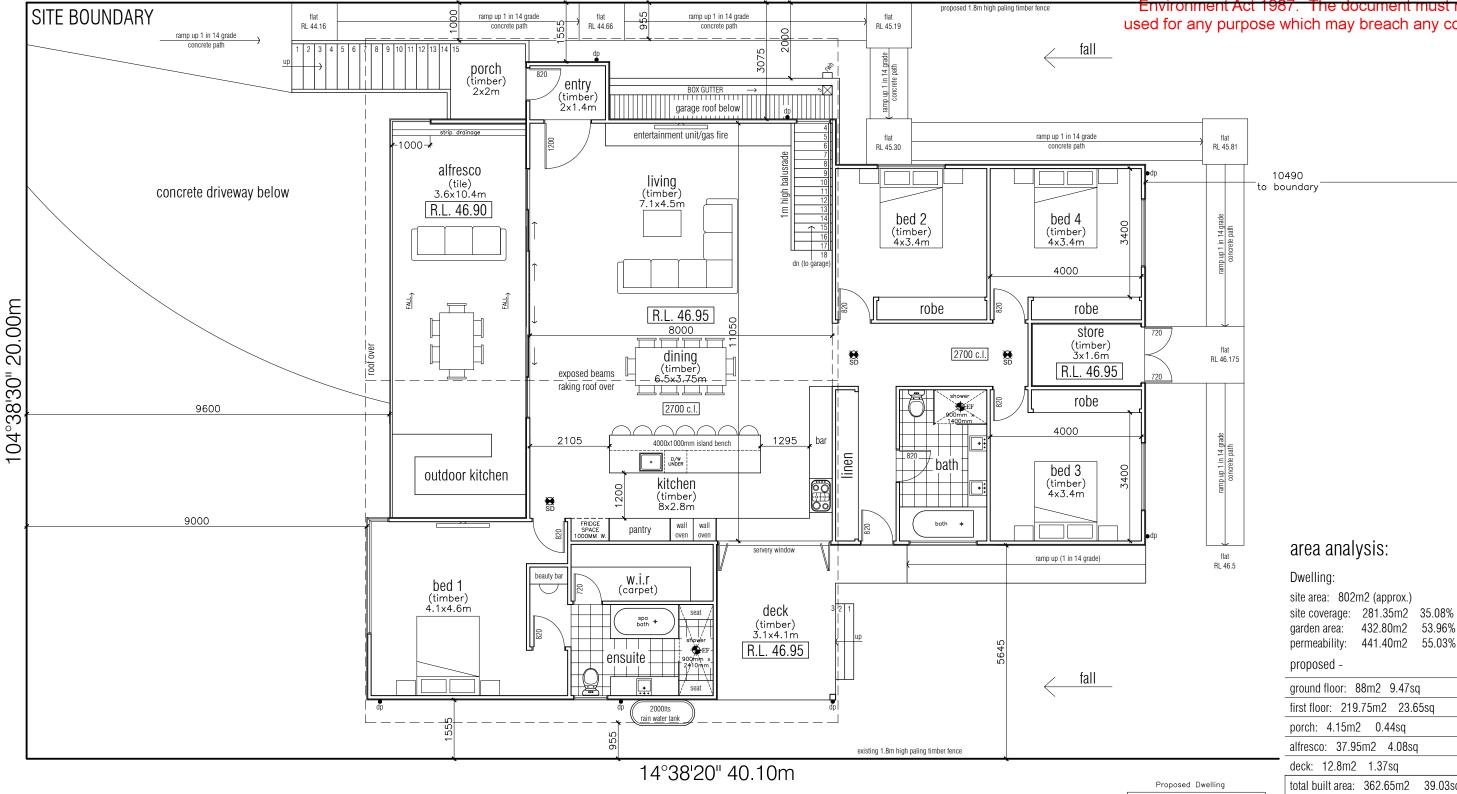

PROPOSED FIRST FLOOR PLAN

-SCALE 1:100

2000 litre rain water tank. 7m(L) x 0.7m(W) x 1.86m(H) rainwater tank to be connected to all sanitry - flushing systems

DATE -

deck: 12.8m2 1.37sg total built area: 362.65m2 39.03sq secluded p.o.s: 338.25m2

p.o.s: 195.05m2

total p.o.s: 533.3m2

REVI	REVISIONS				
REV.	DESCRIPTION	BY	DATE		

 \square

 \supset

0

 \triangleleft

 \leq

⋖

LEGEND -

proposed (block work) wall

proposed (cladding) wall

proposed (framing) wall

This drawing & design must not be copied in part or whole without the written authorisation from LMD Design & Drafting Pty Ltd.

Ver.02 Town Planning

DOCUMENTATION ISSUE

PLANNING (NOT FOR CONSTRUCTION) PRELIMINARY (NOT FOR CONSTRUCTION)

TENDER (NOT FOR CONSTRUCTION) CONSTRUCTION

GENERAL NOTES -

Do not scale drawings, use written dimensions only. These drawings are to be read in conjunction with stamped town planning drawings and all engineering documentation where

Check and verify all dimensions and details on site prior to the commencement of any works, and report any discrepancies or anomalies

to the office of LMD Design & drafting for clarification

These drawings are neither exhaustive or a substitute for regulations, statutory requirements, building practice or contractual obligations, and unless expressly stated otherwise. These notes are provided only as auidelines. No responsibility is accepted for their use.

JOB NO	DRAWN BY -
0999	LD
4000000	

ADDRESS -

Proposed Dwelling

6 Hakea Court, Mallacoota PROJECT -

SCALE -SHEET SIZE DRAWING FOR -Sean Caracella DRAWING -

1:100

Proposed First Floor Plan

NO. - TP07 19/09/2024 **DESIGNER** -LMD Design & Drafting Pty Ltd **BUILDER** -

TBC


NORTH



<u>A</u>: 'Regus' Lower Heidelberg Rd, Heidelberg VIC 3084

Printed 6/02/2025

ADVERTISED This copied document is made available for the sole Proposed schedule of materials and finishes purpose of enabling its consideration and review as (all must be a non-reflective type, muted tones) part of a planning process under the Planning and 1. walls - james hardie 'linea' cladding - painted 'shaley grey finish' Environment Act 1987. The document must not be 2. walls - block work - painted 'shaley grey finish' used for any purpose which may breach any copyright. 3. roof - colorbond - 'bluegum finish' gutter, downpipes - colorbond - 'bluegum finish' 5. fascia - colorbond - 'white finish' 6. windows & doors - aluminium frame - painted 'white finish' posts - timber - painted 'shaley grey finish' 8. driveway, carport, porch & pergola surfaces - natural concrete finish - grey 9. balustrade - glass 10. fencing - timber - light natural finish 11. garage door - white finish 12. decking - composite slats - timber grain 800 fence N.G.L. AT DWELLING N.G.L. AT BOUNDARY GARAGE GROUND F.L R.L. 43.60 NORTH (FRONT) ELEVATION

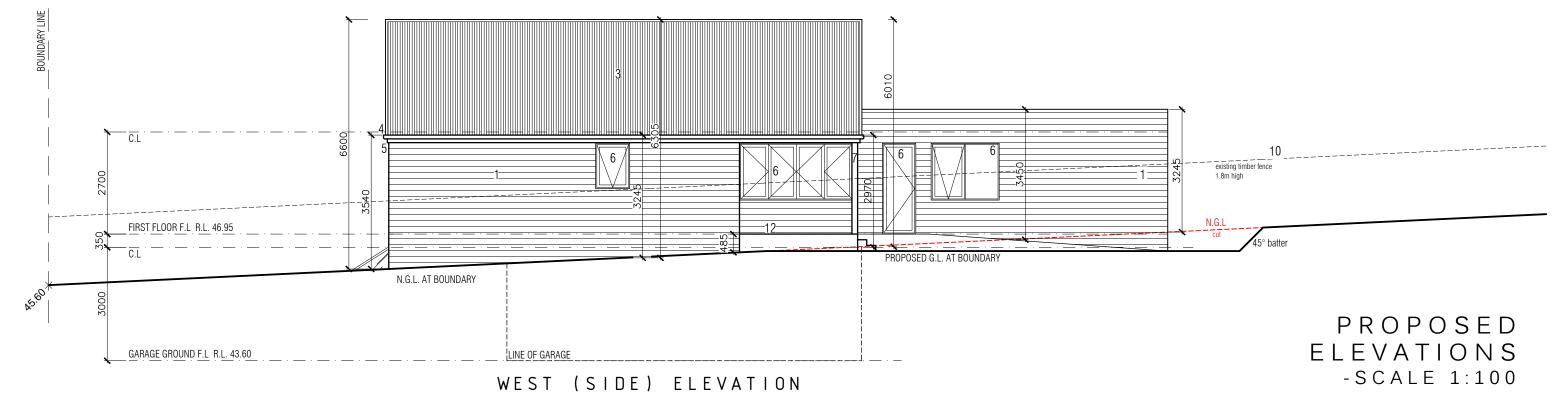





Proposed schedule of materials and finishes -


(all must be a non-reflective type, muted tones)

- 1. walls james hardie 'linea' cladding painted 'shaley grey finish'
- 2. walls block work painted 'shaley grey finish'
- 3. roof colorbond 'bluegum finish'
- gutter, downpipes colorbond 'bluegum finish'
- 5. fascia colorbond 'white finish'
- 6. windows & doors aluminium frame painted 'white finish'
- posts timber painted 'shaley grey finish'
- 8. driveway, carport, porch & pergola surfaces natural concrete finish grey
- 9. balustrade glass
- 10. fencing timber light natural finish
- 11. garage door white finish
- 12. decking composite slats timber grain

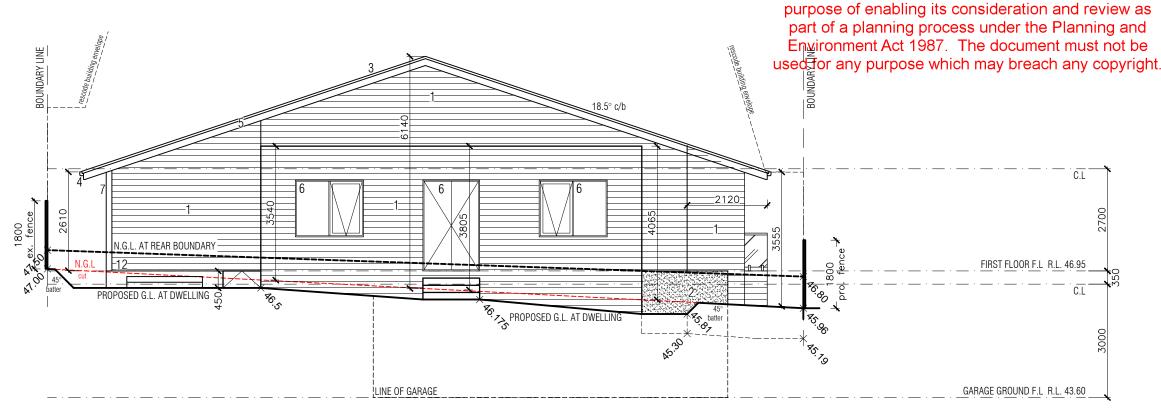

SOUTH (REAR) ELEVATION

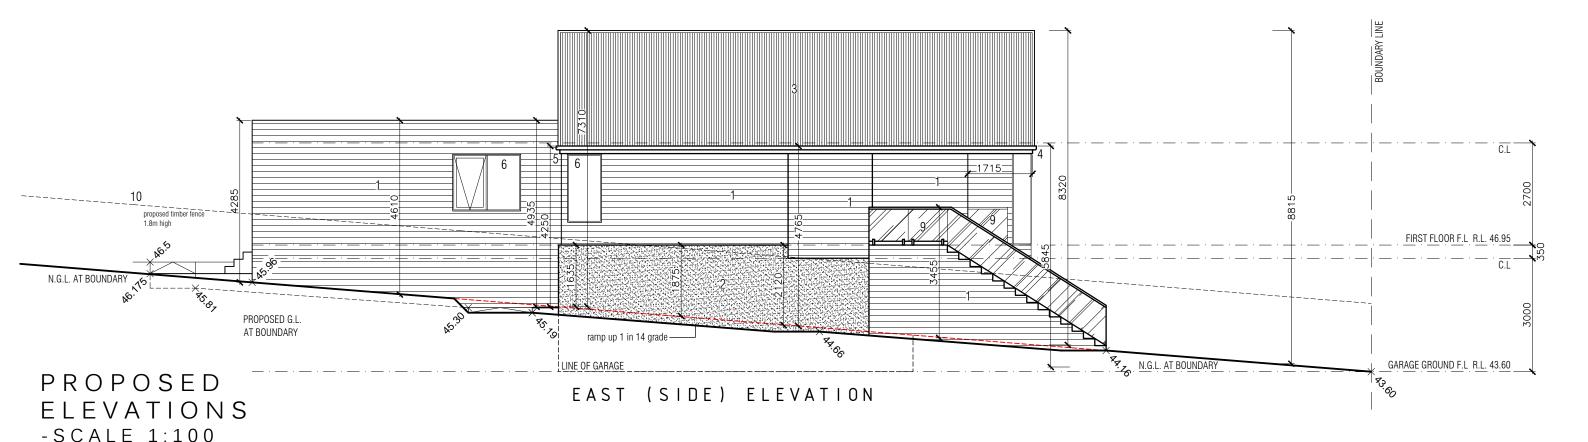

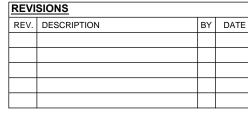

© This drawing & design must not be copied in part or whole without the written authorisation from LMD Design & Drafting Pty Ltd.

RIPTION	BY	DATE

Ver.02 Town Planning

DOCUMENTATION ISSUE

PLANNING (NOT FOR CONSTRUCTION) PRELIMINARY (NOT FOR CONSTRUCTION)

TENDER (NOT FOR CONSTRUCTION) CONSTRUCTION

GENERAL NOTES -

Do not scale drawings, use written dimensions only. These drawings are to be read in conjunction with stamped town planning drawings and all engineering documentation where

Check and verify all dimensions and details on site prior to the commencement of any works, and report any discrepancies or anomalies

to the office of LMD Design & drafting for clarification.

These drawings are neither exhaustive or a substitute for regulations, statutory requirements, building practice or contractual obligations, and unless expressly stated otherwise. These notes are provided only as auidelines. No responsibility is accepted for their use

JOB NO. -DRAWN BY -0999 LD

ADDRESS -6 Hakea Court, Mallacoota

PROJECT -

Proposed Dwelling

SCALE -SHEET SIZE 1:100

FOR -Sean Caracella

DRAWING -

Proposed Elevations

NO. - TP09 DESIGNER -

DRAWING

19/09/2024 LMD Design & Drafting Pty Ltd BUILDER -TBC

DATE -

ADVERTISED This copied document is made available for the sole

A: 'Regus' Lower Heidelberg Rd,
Heidelberg VIC 3084
P: 0474696795
Printed 06/02/2025

ADVERTISED This copied document is made available for the sole SHADOW LEGEND: purpose of enabling its consideration and review as 22 SEPTEMBER (EQUINOX) part of a planning process under the Planning and **ADJOINING SITE** Environment Act 1987. The document must not be LOT 11 / 8 HAKEA COURT PROPOSED DWELLINGS AT 9AM **VACANT** used for any purpose which may breach any copyright. PROPOSED FENCE AT 12PM PROPOSED DWELLINGS AT 3PM 1/94°38'2/0" <u>40.10m</u> water tank 3 000 litre CONCRETE 47.00 CROSSOVER \mathcal{L} $\bigcap_{i \in I} O_i$ \circ GRASS PROPOSED LOWER METAL PROPOSED UPPER METAL SHEET ROOF AT 2° PITCH SHEET ROOF AT A 18.5° PITCH \triangleleft Ш ×,03 \mathbf{Y} ×85.04 **4**5.00 工 SUBJECT SITE LOT 10 / 6 HAKEA COURT APPROX. 802M² *\$5,50 -14°38'20' 45,₆₆ 40.10m 185,>3 CONCRETE CROSSOVER - LEVELS SHOWN ON THIS PLAN ARE TO A.H.D BASED ON
MALLACOOTA PM 55 (R.L. 46.592m) SINGLE STOREY W/B & CEMENT SHEET **DWELLING ADJOINING SITE** PROPOSED SITE/ LOT 9 / 4 HAKEA COURT **OCCUPIED** SHADOW DIAGRAM 9 AM, 12 PM & 3 PM -SCALE 1:200 REVISIONS DATE -**GENERAL NOTES -**JOB NO. -DRAWN BY SCALE -SHEET SIZE DRAWING Ver.02 Town Planning REV. DESCRIPTION BY DATE NO. - TP10 LD 19/09/2024 Do not scale drawings, use written to the office of LMD Design & drafting 0999 1:200 dimensions only. These drawings are for clarification. NORTH FOR -DESIGNER -**DOCUMENTATION ISSUE** ADDRESS to be read in conjunction with These drawings are neither exhaustive stamped town planning drawings and LMD Design & Drafting Pty Ltd 6 Hakea Court, Mallacoota Sean Caracella or a substitute for regulations, all engineering documentation where PLANNING (NOT FOR CONSTRUCTION) statutory requirements, building DRAWING -**BUILDER** practice or contractual obligations, PRELIMINARY (NOT FOR CONSTRUCTION) A: 'Regus' Lower Heidelberg Rd, Heidelberg VIC 3084 Check and verify all dimensions and and unless expressly stated otherwise. PROJECT -Proposed Site/Shadow Diagram TBC TENDER (NOT FOR CONSTRUCTION) details on site prior to the These notes are provided only as 9am, 12pm & 3pm Proposed Dwelling Printed 6/02/2025 commencement of any works, and auidelines. No responsibility is This drawing & design must not be copied in part or whole withou the written authorisation from LMD Design & Drafting Pty Ltd. CONSTRUCTION report any discrepancies or anomalies accepted for their use.

- Refer to BAL Assessment for Bushfire Info.

Architectural plans to comply with all BAL-29 bushfire design requirements from Section 7 of AS3959-2018. Builder to construct accordingly.

Please note, the owner/builder to select alternatives from the info below as per AS 3959-2018 Section 7 and report it to the building surveyor.

SECTION 7: CONSTRUCTION FOR BUSHFIRE ATTACK LEVEL 29 (BAL 29)

This document has been prepared to assist in the preparation of construction certificate plans and specifications in respect to BAL - 29. BAL-29 is primarily concerned with protection of your building from ember attack and burning debris ignited by wind borne embers and radiant heat up to and including 29 AVMIN2. To comply with the Building Code of Natarsila, your construction or complying development certificate plans must include details of the building construction relevant to the level of bushfire. Those parts dis document that relate to your development must be included on the construction retificate plans or in the construction specification. The construction requirements for the next lower BAL may be used for an elevation of a dwelling that is not exposed to the source of a bushfire. An elevation is not exposed if the entire elevation is completely screened from the source of a bushfire by another part of the building. Any element of construction or system that satisfies the test criteria of AS 1530.8.1 may be used in lieu of the applicable requirements below (see Clause 3.8 of the Standard).

SARKING

Sarking, where used for bushfire protection shall be:

- Breather-type sarking complying with AS/NZS4200.1 and with a flammability index of not more than 5 and sarked on the outside
- c. An insulation material conforming to the appropriate Australian Standard for that material

- This Standard does not provide construction requirements for subfloor supports where the subfloor space is enclosed with-
- a wall that complies with the requirements for an external wall below; or
- a mesh or perforated sheet with a maximum aperture of 2 mm, made of corrosion resistant steel, bronze or aluminium; o
- a combination of Items (a) and (b) above.

Where the subfloor space is unenclosed, the support posts, columns, stumps, piers and poles shall be-

- (1) of non-combustible material; or
- (2) of bushfire-resisting timber (refer to the table at the end of this document); or
- (3) a combination of Items (i) and (ii) above.

This requirement applies to the principal building only. See requirements below for verandas, decks, steps, ramps and

FLOORS

- Elevated floors

The Standard does not provide construction requirements for elevated floors, including bearers, joists and flooring, where the subfloor space is enclosed with--

i) a wall that complies with the standards for an external wall below; or

ii)ii) a mesh or perforated sheet with a maximum aperture of 2 mm, made of corrosion resistant steel, bronze or aluminium; or

- iii) iii) a combination of Items (a) and (b) above. b) Unenclosed subfloor space Where the subfloor space is unenclosed, the bearers, joists and flooring, less than 400 mm above finished ground level, shall be one of the following: i) materials that comply with the following: (a) bearers and joists shall be— i) non-combustible; or ii) bushfire-resisting timber (refer to the table at the end of this document); or iii) a combination of Items (i) and (ii) above.
- b) Unenclosed subfloor space

Where the subfloor space is unenclosed, the bearers, joists and flooring, less than 400 mm above finished ground level, shall

i) materials that comply with the following:

(a) bearers and joists shall be

ii)bushfire-resisting timber (refer to the table at the end of this document); or iii) a combination of Items (i) and (ii) above.

(a) flooring shall be--

ii)bushfire-resisting timber (refer to the table at the end of this document); or

timber (other than bushfire-resisting timber), particleboard or plywood flooring where the underside is lined with sarking-type material or mineral wool insulation; or

c) a combination of any of Items (i), (ii) or (iii) above; or

This Standard does not provide construction requirements for elements of elevated floors, including bearers, joists and flooring, if the underside of the element is 400 mm or more above finished ground level.

EXTERNAL WALLS

REVISIONS

- - (a) Non-combustible material such as cavity brick, masonry veneer walls with an outer leaf of clay, concreacious silicate or natural stone, precast or in situ walls of concrete or aerated concrete or earth walling inclinate brick; or multiplick; or
 - (b) Timber logs of a species with a density of 680 kg/m3 or greater at a 12 percent moisture content; of a minimum nominal overall thickness of 90 mm and a minimum thickness of 70 mm (see Clause 3.11of Standard); and gauge
 - (c) Cladding that is fixed externally to a timber-framed or a steel-framed wall and is-
 - (i) Fibre-cement a minimum of 6 mm in thickness; or
 - (ii) Bushfire-resisting timber (refer to the table at the end of this document); o
 - (iii) Steel sheeting; or
 - (iv) A combination of any of Items (i), (ii) or (iii) above; or
 - (d) A combination of any of Items (a), (b) or (c) above.
- Joints All joints in the external surface material of walls shall be covered, sealed, overlapped, backed or butt-jointed to prevent
- 3) Vents and weepholes Vents and weepholes in external walls shall be screened with a mesh with a maximum aperture of 2 mm made of corrosion-resistant steel, bronze or aluminium, except where the vents and weepholes have an aperture less than 3 mm. EXTERNAL WINDOWS and DOORS
- Windows Window assemblies shall comply with one of the following:
 - (a) They shall be completely protected by a bushfire shutter that complies with Note 1 below; or
 - They shall comply with the following:
 - (i) Window frames and window joinery shall be made from

- (A) Bushfire-resisting timber (refer to the table at the end of this document); or
- (B) Metal; or
- (C) Metal-reinforced PVC-U. The reinforcing members shall be made from aluminium, stainless steel, or n-resistant steel and the frame and sash shall satisfy the design load, performance and structural strength of
 - (ii) Externally fitted hardware that supports the sash in its functions of opening and closing shall be metal.
- (iii) Glazing shall be a minimum of 5 mm toughened glass.
- Where double-glazed units are used, the above requirements apply to the external face of the window assembly only.
 - (iv) Where glazing is less than 400 mm from the ground or less than 400 mm above decks, carport roofs, awnings and similar elements or fittings, having an angle less than 18 degrees to the horizontal and extending more than 110 mm in with from the window frame, that portion shall be screened with a screen that complies with Note 2 below.
- (iv)The openable portion of windows shall be screened with screens complying with Note 2 below.

Screening of the openable portions of all windows is required in all BALs to prevent the entry of embers to the building when the window is open. Screening of the openable and fixed portions of some windows is required in some BALs to reduce the effects of radiant heat on some types of glass.

If the screening is required to reduce the effects of radiant heat on the glass, the screening has to be external so that the glass in the openable portion of the window will be 'protected' when it is shut.

If the screening is required only to prevent the entry of embers, the screening may be fitted externally or inter

3) Doors--Side-hung external doors (including French doors, panel fold and bi-fold doors)

Side-hung external doors, including French doors, panel fold and bi-fold doors, shall comply with one of the following:

- (a) Doors and door frames shall be protected by bushfire shutters that comply with Note 1; o
- (b) Doors and door frames shall be protected externally by screens that comply with Note 2: or
- Doors and door frames shall comply with the following:

- non-combustible; o
- (B) a solid timber, laminated timber or reconstituted timber door, having a minimum thickness of 35 mm for the first 400 mm above the threshold; or
- (C) a door, including a hollow core door, protected externally by a screen that complies with Note 2 below; or (D) a fully framed glazed door, where the framing is made from noncombustible materials or from bushfire resisting timber (refer to the table at the end of this document).
- (ii) Externally fitted hardware that supports the panel in its function of opening and closing shall be meta
- (iii) Where doors incorporate glazing, the glazing shall be toughened glass with a minimum thickness of 6mm.
- (iv) Doors shall be tight-fitting to the door frame and to an abutting door, if applicable.
- (v) Door frames shall be made from:
- Bushfire-resisting timber (refer to the table at the end of this document); or
- (C) Metal-reinforced PVC-U. The reinforcing members shall be made from aluminium, stainless steel, or n-resistant steel and the door assembly shall satisfy the design load, performance and structural strength of
- (vi) Where glazing is less than 400 mm from the ground or less than 400 mm above decks, carport roofs, awnings and similar elements or fittings, having an angle less than 18 degrees to the horizontal and extending more than 110 mm in width from the window frame, that portion shall be screened with a screen that complies with Note 2 below.
- (vii) Weather strips, draught excluders or draught seals shall be installed at the base of side-hung external doors
- Sliding doors shall comply with one of the following:
- (a) They shall be completely protected by a bushfire shutter that complies with Note 1; or
- (b) They shall be completely protected externally by screens that comply with Note 2; or
- Any glazing incorporated in sliding doors shall be toughened glass with a minimum thickness of 6mm
- (ii) Both the door frame supporting the sliding door and the framing surrounding any glazing shall be made from
- sisting timber (refer to the table at the end of this document); or
- (C) Metal-reinforced PVC-U. The reinforcing members shall be made from aluminium, stainless steel, or corrosion-resistant steel and the frame and the sash shall satisfy the design load, performance and structustrength of
- (iii) There is no requirement to screen the openable part of the sliding door. However, if screened, the screens

NOTE: The construction of manufactured sliding doors should prevent the entry of embers when the door is closed. There is no requirement to provide screens to the openable part of these doors as it is assumed that a sliding door will be closed if occupants are not present during a bushfire event. Screens of materials other than those specified may not resist ember attack.

- (iv) Fxternally fitted hardware that supports the panel in its function of opening and closing shall be metal
- (v) Sliding doors shall be tight-fitting in the frames
- (e) Garage Doors
- The following apply to vehicle access doors:
- (a) The lower portion of a vehicle access door that is within 400 mm of the ground when the door is closed shall be made from:
- (i) Non-combustible material: or
- Bushfire-resisting timber (refer to the table at the end of this document); or
- (iii) Fibre cement sheet, a minimum of 6 mm in thickness; or A combination of any of Items (i), (ii) or (iii) above.
- (b) Panel lift, tilt doors or side-hung doors shall be fitted with suitable weather strips, draught excluders, draught s or guide tracks, as appropriate to the door type, with a maximum gap no greater than 3 mn
- Roller doors shall have guide tracks with a maximum gap no greater than 3 mm and shall be fitted with a nylon
- (d) Vehicle access doors shall not include ventilation slots

Note 1: Where fitted, bushfire shutters shall be made from

- non-combustible material, or
- bushfire-resisting timber (refer to the table at the end of this document), or
- a combination of any of Items (a) or (b) above; and
 - (i) be fixed to the building and be non-removabl
 - (ii) when in the closed position, have no gap greater than 3 mm between the shutter and the wall, the sill or the
 - (iii) be readily manually operable from either inside or outside
 - (iv) protect the entire window assembly or door assembly;

 - (A) uniformly distributed perforations with a maximum aperture of 3 mm when the shutter is providing radiant hea protection or 2 mm when the shutter is also providing ember protection (such as where the openable portion of the window is not screened in accordance with the requirements of the respective BAL); and
 - (B) a perforated area no greater than 20% of the shutter. If bushfire shutters are fitted to all external doors then a

Note 2: Where fitted, screens for windows and doors shall have a mesh or perforated sheet with a maximum aperture of 2 mm, made of corrosion-resistant steel, bronze or aluminium. Gaps between the perimeter of the screen assembly and the building element to which it is fitted shall not exceed 3 mm.

The frame supporting the mesh or perforated sheet shall be made from metal or a timber species as specified at the end of this

Note 3: Where double glazed units are used the above requirements apply to the external face of the window assembly only.

ROOFS (INCLUDING VERANDA AND ATTACHED CARPORT ROOFS, PENETRATIONS, FAVES, FASCIAS, GABLES, GUTTERS

- General
- The following apply to all types of roofs and roofing systems:
- (a) roof tiles, roof sheets and roof-covering accessories are to be non-combustible
- the roof/wall junction is to be sealed to prevent openings greater than 3 mm, either by the use of fascia and eaves linings or ling between the top of the wall and the underside of the roof and between the rafters at the line of the wall.
 - (c) roof ventilation openings, such as gable and roof vents, are to be fitted with ember guards made of ombustible material or a mesh or perforated sheet with a maximum aperture of 2 mm, made of corrosion-resistant steel, bronze or aluminium
 - (d) a pipe or conduit that penetrates the roof covering shall be non-combustible
- Tiled roofs shall be fully sarked. The sarking shall--
 - (a) be located on top of the roof framing, except that the roof battens may be fixed above the sarking;
 - (b) cover the entire roof area including ridges and hips; and
- (c) extend into gutters and valleys.
- Sheet roofs shall-
 - (a) be fully sarked, except that foil-backed insulation blankets may be installed over the battens; and
 - (b) have any gaps greater than 3 mm (such as under corrugations or ribs of sheet roofing and between roof components) sealed at the fascia or wall line and at valleys, hips and ridges by--
 - (i) a mesh or perforated sheet with a maximum aperture of 2 mm, made of corros aluminium; or
 - (ii) mineral wool: or
 - (iii) other non-combustible material: or
 - (iv) a combination of any of Items (i), (ii) or (iii) above.
 - Note: Sarking is used as a secondary form of ember protection for the roof space to account for minor gaps that may develop in sheet roofing.
- Verandah, carport and awning roofs
- The following apply to veranda, carport and awning roofs:
 - (a) A veranda, carport or awning roof forming part of the main roof space shall meet all the requirements for the
 - (b) A veranda, carport or awning roof separated from the main roof space by a wall that complies with the specification above for an external wall shall have a non-combustible roof covering and the support structure shall

 - (ii) bushfire-resisting timber (refer to the table at the end of this document); or
 - (iii) timber rafters lined on the underside with fibre-cement sheeting a minimum of 6 mm in thickness, or with
- material complying with AS 1530.8.1: or (iv) a combination of any of Items (i), (ii) or (iii) above
- The following apply to roof penetrations
 - (a) Roof penetrations, including roof lights, roof ventilators, roof-mounted evaporative cooling units, aerials, ver pipes and supports for solar collectors, shall be adequately sealed at the roof to prevent gaps greater than 3 mm. The material used to seal the penetration shall be non-combustible.
- (b) Openings in vented roof lights, roof ventilators or vent pipes shall be fitted with ember guards made from a mesh or perforated sheet with a maximum aperture of 2 mm, made of corrosion-resistant steel, bronze or aluminium
- This requirement does not apply to the exhaust flues of heating or cooking devices with closed combustion chambers. In the case of gas appliance flues, ember guards shall not be fitted. Gasfitters are required to provide a metal flue pipe above the roof and terminate with a certified gas flue cowl complying i6. Advice may be obtained from State gas technical regulators.
 - (a) All overhead glazing shall be Grade A safety glass complying with AS 1288.
 - (b) Glazed elements in roof lights and skylights may be of polymer provided a Grade A safety glass diffuser complying with AS 1288, is installed under the glazing. Where glazing is an insulating glazing unit (IGU), Grade A toughened safety glass minimum 4 mm thickness, shall be used in the outer pane of the IGU. (c) Flashing elements of tubular skylights shall be non-combustible. However, they may be of an alternative material, provided the integrity of the roof covering is maintained by an under-flashing made of non-combustible

The following apply to eaves linings, fascias and gables:

Eaves linings, fascias and gables

(a) Gables shall comply with the requirements for an external wa

aperture of 2 mm, made of corrosion-resistant steel, bronze or aluminium

- (b) Fascias and bargeboards shall--
- where timber is used, be made from bushfire-resisting timber (refer to the table at the end of this document); or where made from metal, be fixed at 450 mm centres; or

ADVERTISED This copied document is made available for the sole

purpose of enabling its consideration and review as

part of a planning process under the Planning and

Environment Act 1987. The document must not be

used for any purpose which may breach any copyright.

(d) External single plane glazed elements of roof lights and skylights, where the pitch of the glazed element is 18 degrees or less to the horizontal, shall be protected with ember guards made from a mesh or perforated sheet with a maximum aperture of 2 mm, made of corrosion-resistant steel, bronze or aluminium.

(e) Evaporative cooling units shall be fitted with non-combustible butterfly closers as close as practicable to the roof level or the unit shall be fitted with non-combustible covers with a mesh or perforated sheet with a maximum

- (c) Eaves linings shall be--
- (i) fibre-cement sheet, a minimum 4.5 mm in thickness; or
- (ii) bushfire-resisting timber (refer to the table at the end of this document); or
- (iii) a combination of Items (i) and (ii) above.
- (d) Eaves penetrations shall be protected the same as for roof penetrations
- (e) Eaves ventilation openings greater than 3 mm shall be fitted with ember guards made of non-combustible material or a mesh or perforated sheet with a maximum aperture of 2 mm, made of corrosion-resistant steel, bronze
- (f) Joints in eaves linings, fascias and gables may be sealed with plastic joining strips or timber storm moulds
- Gutters and downpipes

If installed, gutter and valley leaf guards shall be non-combustil With the exception of box gutters, gutters shall be metal or PVC-U.

Box gutters shall be non-combustible and flashed at the junction with the roof with noncombustible material. VERANDAHS, DECKS, STEPS, RAMPS AND LANDINGS

- 2) Enclosed subfloor spaces of verandas, decks, steps, ramps and landings a) Materials to enclose a subfloor space

Supports

i) the material used to enclose the subfloor space complies with the standards for external walls above; and

ii)all openings greater than 3 mm are screened with a mesh or perforated sheet with a maximum aperture of 2 mm, made of

The Standard does not provide construction requirements for support posts, columns, stumps, stringers, piers and poles

General Decking may be spaced. There is no requirement to enclose the subfloor spaces of verandas, decks, steps, ramps or

- The Standard does not provide construction requirements for the framing of verandas, decks, ramps or landings (i.e., bearen d) Decking, stair treads and the trafficable surfaces of ramps and landings
- Decking, stair treads and the trafficable surfaces of ramps and landings shall be-
- ii)of bushfire-resisting timber (refer to the table at the end of this document); or
- iii) a combination of Items (i) and (ii) above. 3) Unenclosed subfloor spaces of verandas, decks, steps, ramps and landings
- a) Supports Support posts, columns, stumps, stringers, piers and poles shall be-
- i) of non-combustible material: or ii)of bushfire-resisting timber (refer to the table at the end of this document); or
- iii) a combination of Items (i) and (ii) above.

4) Balustrades, handrails or other barriers

- Framing of verandas, decks, ramps or landings (i.e., bearers and joists) shall be
- i) of non-combustible material: or ii)of bushfire-resisting timber (refer to the table at the end of this document);or iii) a combination of Items (i) and (ii) above
- Decking, stair treads and the trafficable surfaces of ramps and landings Decking, stair treads and the trafficable surfaces of ramps and landings shall be-
- i) of non-combustible material; or ii) of bushfire-resisting timber (refer to the table at the end of this document) or iii) a combination of Items (i) and (ii) above.
- Those parts of the handrails and balustrades less than 125 mm from any glazing or any combustible wall shall be-
- ii)of bushfire-resisting timber (refer to the table at the end of this document):or

iii) a combination of Items (i) and (ii) above. Those parts of the handrails and balustrades that are 125 mm or more from the building have no requirements WATER AND GAS SUPPLY PIPES

DATE -

19/09/2024

Above-ground, exposed water and gas supply pipes are to be metal. BUSH FIRE RESISTING SPECIES

The following species have been tested and meet the requirements for a bush fire resisting timber species Ash silverton Blackbutt Gum, red, river

Gum, spotted

Ironbark, red

DRAWING

NO. - TP11

Kwila (Merbau)

BAL 29 NOTES

BY DATE REV. DESCRIPTION

This drawing & design must not be copied in part or whole without the written authorisation from LMD Design & Drafting Pty Ltd.

Ver.02 Town Planning

PLANNING (NOT FOR CONSTRUCTION) PRELIMINARY (NOT FOR CONSTRUCTION)

TENDER (NOT FOR CONSTRUCTION)

CONSTRUCTION

DOCUMENTATION ISSUE

GENERAL NOTES -

details on site prior to the

Do not scale drawings, use written dimensions only. These drawings are to be read in conjunction with stamped town planning drawings and all engineering documentation where Check and verify all dimensions and

commencement of any works, and

report any discrepancies or anomalies

to the office of LMD Design & drafting for clarification These drawings are neither exhaustive

or a substitute for regulations, statutory requirements, building practice or contractual obligations, and unless expressly stated otherwise. These notes are provided only as auidelines. No responsibility is accepted for their use.

JOB NO. -DRAWN BY -0999 LD ADDRESS -

6 Hakea Court, Mallacoota PROJECT -

Proposed Dwelling

SCALE -SHEET SIZE FOR -Sean Caracella

DESIGNER-LMD Design & Drafting Pty Ltd DRAWING -BUILDER -**Bal Notes** TBC



Printed 06/02/2025

Page 15 of 15